ELDREDGE SURVEYING & ENGINEERING, LLC

1038 Main Street Chatham, Massachusetts 02633

LETTER OF TRANSMITTAL

July 28, 2017

CHATHAM PLANNING BOARD

Town Hall 595 Main Street Chatham, MA 02633

Re: **DEFINITVE SITE PLAN -**

Frank O'Keefe, LLC, Owner c/o Frederick Bierwirth P.O. Box 56 North Chatham, MA 02650

Dear Members:

On behalf of the owner, Frank O'Keefe, LLC, enclosed please find the following:

- 1. Two (2) full size and ten (10) reduced copies of each of the following plans:
 - Sheet 1 of 2 Existing Conditions Plan, dated -7-24-2017
 - Sheet 2 of 2 Definitive Site Plan dated 07-24-2017
 - Architectural Plans sheets A1-15 and S1- S4; and ME1-ME3
 - Landscape Plan Prepared by Sorbello Landscaping, Inc. dated 06-13-2017
- 2. Drainage Details, sheets 1 and 2 of 2; and
- 3. Drainage calculations, sheets 1 4 of 4
- 4. Soil boring log
- 5. 12 copies of **Application** for Site Plan Review;
- 6. 2 copies of the Cost Estimate;
- 7. List of abutters;

- 8. Filing fee in the amount of \$1,095.001, payable to the Town of Chatham); and
- 9. Copy of current deeds.

The project consists of:

The demolition of the existing structure to the foundation followed shortly thereafter with the construction of a new building. The footprint is being expanded to include a porch and the deck on the westerly side is being modified.

Inside, the applicants are proposing a fitness center, workshare office space and a juice bar. A childcare facility incidental to the fitness center and shared workspace is being provided.

The parking calculations have been reviewed and an estimated 56 spaces are required where 53 are provided on the site. The waiver request for the deficient parking is based on the fluctuating times for the various uses combined with rights to park on adjacent properties.

The drainage design has been modified from the Pre-Application Site Plan. The front parking lot is proposed to be regraded to alleviate the puddle that forms there by diverting the stormwater runoff into the existing catch basin to the east and a proposed catch basin to the west. This divides the stormwater runoff from the northerly portion of the property to two independent leaching systems.

The drainage design has an additional twist. The drainage areas have been divided into five: 1A, 1B, 1C, 2 and 3.

- 1A is the area of contribution on the abutting property that enters the existing catch basin on the subject property.
- 1B and 1C are the areas of contribution that currently contribute to the same catch basin as 1A. These have been divided as the proposed regrading will direct the runoff from area 1B to the existing catch basin and the runoff from 1C to the proposed catch basin.
- 2 is the area of contribution generated from the roof on the rear of the building.
- 3 is the area of contribution generated from the remainder of the property.

Area 1A generates slightly more stormwater runoff than Area 3.

The proposal is to collect and dispose of the stormwater runoff generated from Areas 1A, 1B, 1C and 2. The runoff from Area 3 is to continue in the historical pattern onto the abutters' property.

This system design results in the applicant taking responsibility an amount of stormwater generated from the applicant's property without requesting that the neighbor go to the expense to upgrade their drainage infrastructure. This will substantially decrease the runoff that is currently draining onto the abutting property.

It is my understanding that the Public Hearing for this project will be held on Tuesday, August 22, 2017 at or after 7:00PM.

Respectfully,

ELDREDGE SURVEYING & ENGINEERING, LLC

J. Thaddeus Eldredge, PLS

JTE/gee enc.

C-4693-01.0 Copy: Fred & Lindsay Bierwirth James Norcross

Y:\Clients\Bierwirth, Fred 4693\Planning Board\Definitive\04 LOT Def Site Plan2017-07-28 - Copy.docx



APPLICATION FOR SITE PLAN REVIEW*/++



	Scheamea Key	
	Application Fee Paid:	
plicant Information:		
- · · · · · · · · · · · · · · · · · · ·		
Assessor's Map:	Lot:	
Applicant Name:		
Applicant Phone #:	Fax #:	
Owner Name/Address/Phone (if not a	applicant):	
The owner's title to the land is derive	ed from	
by deed dated	and recorded in Barnstable Registry of Deeds Book	Page,
registered in the Barnstable District I	Registry District of the Land Court, Certificate of Title No	
Engineer/Surveyor:		
	oosed use or uses of the property. Provide as much information as	s possible, attach additional pages
if needed):	existing conditions and any proposed changes.	
if needed): te Plan: Include Site Plan showing Estimated Cost of Site Improvements: cost including but not limited to the	existing conditions and any proposed changes. c (provide estimated cost of all site improvements from a contractor following: paving, drainage, sidewalks, handicap access facilities,	or exclusive of building construction
if needed): te Plan: Include Site Plan showing Estimated Cost of Site Improvements: cost including but not limited to the retaining walls, outdoor lighting and	existing conditions and any proposed changes. c (provide estimated cost of all site improvements from a contractor following: paving, drainage, sidewalks, handicap access facilities,	or exclusive of building construction refuse storage and disposal facilitie
if needed): te Plan: Include Site Plan showing Estimated Cost of Site Improvements: cost including but not limited to the retaining walls, outdoor lighting and Estimated Cost:	existing conditions and any proposed changes. (provide estimated cost of all site improvements from a contractor following: paving, drainage, sidewalks, handicap access facilities, landscaping): Prepared by:	or exclusive of building construction refuse storage and disposal facilitie
te Plan: Include Site Plan showing Estimated Cost of Site Improvements: cost including but not limited to the retaining walls, outdoor lighting and Estimated Cost: Total land area involved: rmula Business Establishment: Two (2) or more of the following iter	existing conditions and any proposed changes. It (provide estimated cost of all site improvements from a contractor following: paving, drainage, sidewalks, handicap access facilities, landscaping): Prepared by: Zoning Classification: ins: standardized (Formula) array of services and/or merchandise focture, façade, layout, uniforms, color scheme, and which are utilize ownership or location. Yes No No	or exclusive of building construction refuse storage and disposal facilitic Date: bate: including menu, trademark, logo,
te Plan: Include Site Plan showing Estimated Cost of Site Improvements: cost including but not limited to the retaining walls, outdoor lighting and Estimated Cost: Total land area involved: Trotal land area involved: Two (2) or more of the following iter service mark, symbol, décor, archite businesses worldwide regardless of c If YES, Zoning Board of Appeal	existing conditions and any proposed changes. It (provide estimated cost of all site improvements from a contractor following: paving, drainage, sidewalks, handicap access facilities, and landscaping): Prepared by: Zoning Classification: ins: standardized (Formula) array of services and/or merchandise in the country factors, facto	or exclusive of building construction refuse storage and disposal facilitic Date: bate: including menu, trademark, logo,
te Plan: Include Site Plan showing Estimated Cost of Site Improvements: cost including but not limited to the retaining walls, outdoor lighting and Estimated Cost: Total land area involved: Frmula Business Establishment: Two (2) or more of the following iter service mark, symbol, décor, archite businesses worldwide regardless of c If YES, Zoning Board of Appeal Signed:	existing conditions and any proposed changes. It (provide estimated cost of all site improvements from a contractor following: paving, drainage, sidewalks, handicap access facilities, landscaping): Prepared by: Zoning Classification: ins: standardized (Formula) array of services and/or merchandise focture, façade, layout, uniforms, color scheme, and which are utilize ownership or location. Yes No No	or exclusive of building construction refuse storage and disposal facilities

Town of Chatham - Planning Board Address: 261 George Ryder Road, Chatham, MA 02633

Phone: (508)-945-5168 Fax: (508)-945-5163

Cost Estimate

Bierwirth - Chatham Works, LLC Job #: 4693

Pavement 171	50 S.F. @ \$2.5/S.F.	Allowance:	\$42,875
Drainage	2 catch basins @ \$2000 ea 4 leach pits @ \$2500 ea 2 Dry Wells @ \$500 ea		\$4,000 \$10,000 \$1,000
Retaining Wa	lls 96 L.F. @ \$300/L.F.		\$28,800
Landscaping		Allowance:	\$1,500
Refusal Dispo	osal	Allowance:	\$500
Sidewalk/han	dicap access	Allowance:	\$5,000
Outdoor Light	ting	Allowance:	\$500
		Total: Approx.	\$94,175 \$95,000

DEOUTE	T COD ADJUSTMENT
REGUES	T FOR ABUTTERS' LIST
DATE REQUESTED	July 27, 2017
LOCATION OF	
SUBJECT PROPERTY	323 Orleans Road
REQUEST FOR ABUTTERS WITHIN HOW MANY FEET	E
OF SUBJECT PROPERTY	300'
PURPOSE FOR ABUTTERS' LIST	7D A
VÒOLLEVO FIOL	ZBA
NAME OF PERSON(S)	
REQUESTING ABUTTERS'	O-II Filter I
LIGI	Gail Eldredge PLEASE PRINT
SIGNATURE	Lave Earneage
	- Contract -
TELEPHONE NUMBER	508 945-3965
	* 8
508 945-3550	
FOR AS	SESSORS' USE ONLY
ABUTTERS' LIST COMPLETED BY:	JK .
	VILOUIS
DATE COMPLETED	
PARCEL ID OF SUBJECT PROPERTY	141 41 14 A.
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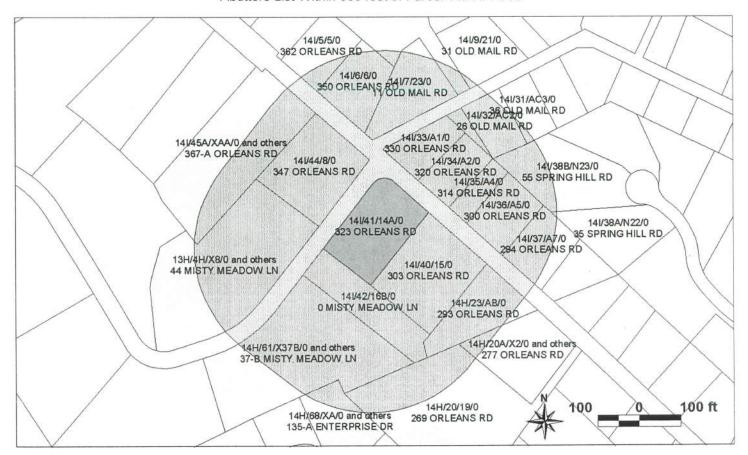
BOARD OF ASSESS. PS TOWN OF CHATTAGES



TOWN OF CHATHAM, MA BOARD OF ASSESSORS 549 MAIN STREET CHATHAM MA 02633



Abutters List Within 300 feet of Parcel 14I/41/14A/0



Key	Parcel ID	Owner	Location	Mailing Street	Mailing City	ST	ZipCd/Country
1919	13H-4A-X1-0-R	FERLITA JANET	36 MISTY MEADOW LN	APT 1 36 MISTY MEADOW LN	N CHATHAM	MA	02650
1920	13H-4B-X2-0-R	DUARTE HEATHER	36 MISTY MEADOW LN	PO BOX 64	N CHATHAM	MA	02650-0064
1921	13H-4C-X3-0-R	REDMOND THOMAS A	36 MISTY MEADOW LN	PO BOX 475	N CHATHAM	MA	02650
1922	13H-4D-X4-0-R	TAVALONE PAUL J	36 MISTY MEADOW LN	76 QUAKER LN	BOLTON	MA	01740
1923	13H-4E-X5-0-R	WEBSTER EDMUND JR & ABIGAIL DOHER NANCY NOMINEE TRUST	44 MISTY MEADOW LN	PO BOX 75	CHATHAM	MA	02633
1924	13H-4F-X6-0-R	HAMMOND JANE	44 MISTY MEADOW LN	12 JUNIPER DR	MASHPEE	MA	02649-2146
1925	13H-4G-X7-0-R	ANDERSON RITA M	44 MISTY MEADOW LN	44 MISTY MEADOW LN #7	N CHATHAM	MA	02650
1926	13H-4H-X8-0-R	HOWARD ROBERT F III & CECILIA B	44 MISTY MEADOW LN	136 POWDER HILL RD	BEDORD	NH	03110
7903	13H-PORT-VLG1-0-E	PORTSIDE VILLAGE CONDO 1	0 MISTY MEADOW LN	0 MISTY MEADOW LN	CHATHAM	MA	02633
2683	14H-20-19-0-R	COLONIAL GAS CO DBA NATIONAL GRID	269 ORLEANS RD	PROPERTY TAX DEPT 40 SYLVAN RD	WALTHAM	MA	02451
2684	14H-20-X1-0-R	MILLER JOHN	275 ORLEANS RD	PO BOX 79	S CHATHAM	MA	02659-0079
2692	14H-23-AB-0-R	293 ORLEANS ROAD LLC	293 ORLEANS RD	17 BUCKINGHAM ST	CAMBRIDGE	MA	02138
2737	14H-61-X37A-0-R	DOYLE STEPHEN HD & BRIDGET K	37-A MISTY MEADOW LN	6 CHATHAM WAY	S HADLEY	MA	01075
8459	14H-61-X37B-0-R	ALAIMO JAMES J JR	37-B MISTY MEADOW LN	PO BOX 1120	ENFIELD	СТ	06083-1120
8220	14H-61-X39-0-R	KONOPKA JOAN	39 MISTY MEADOW LN	PO BOX 103	CHATHAM	MA	02633

Key	Parcel ID	Owner	Location	Mailing Street	Mailing City	20.00	ZipCd/Country
8458	14H-61-X41A-0-R	HUFNAGEL JAMES M & PAMELA S	41-A MISTY MEADOW LN	49 GEORGETOWN CT	BASKING RIDGE	NJ	07920
8460	14H-61-X41B-0-R	STAMP WILLIAM J & HEIDI A	41-B MISTY MEADOW LN	41-B MISTY MEADOW LN	N CHATHAM	MA	02650
8461	14H-61-X43A-0-R	43A MISTY MEADOW LN REALTY TRUST THOMAS P KING JR TRUSTEE	43-A MISTY MEADOW LN	14 WALNUT HILL DR	SCITUATE	MA	02066
8462	14H-61-X43B-0-R	MAZZER THOMAS C & MARIA C	43-B MISTY MEADOW LN	43B MISTY MEADOW LN	N CHATHAM	MA	02650-1138
12913	14H-68-XA-0-R	SWENSON PETER E TR SWENSON JUDITH L TR	135-A ENTERPRISE DR	1370 MAIN ST	CHATHAM	MA	02633
12914	14H-68-XB-0-R	PETER E & JUDITH L SWENSON TRUSTS	135-B ENTERPRISE DR	1370 MAIN ST	CHATHAM	MA	02633
12915	14H-68-XC-0-R	FLOCCO THOMAS J	135-C ENTERPRISE DR	256 SHERIDAN RD	WINNETKA	IL	60093
12916	14H-68-XD-0-R	LONGERSTAEY JACQUES M IPEKDJIAN DIANA N	135-D ENTERPRISE DR	2209 WRENWOOD PONT CT	CHARLOTTE	NC	28211-1800
12917	14H-68-XE-0-R	TISQUANTUM ROAD LLC	135-E ENTERPRISE DR	109 TISQUANTUM ROAD	CHATHAM	MA	02633
2685	14H-20A-X2-0-R	BOBER MATTHEW D & NANCY D	277 ORLEANS RD	44 NONANTUM LN	CHATHAM	MA	02633
2686	14H-20B-X3-0-R	279 ORLEANS RD LLC STEPHEN W WILLIAMS	279 ORLEANS RD	279 ORLEANS RD	N CHATHAM	MA	02650
2687	14H-20C-X4-0-R	BOYLE KEVIN M & ELLEN WRAGA	281-1 ORLEANS RD	3 D APPLEWOOD DR	BALLSTON LAKE	NY	12019
2688	14H-20D-X5-0-R	ERENO RODRIGO	281-2 ORLEANS RD	PO BOX 281	SOUTH CHATHAM	MA	02659
2689	14H-20E-X6-0-R	OCONNELL THOMAS R	281-3 ORLEANS RD	281 ORLEANS UNIT 3	N CHATHAM	MA	02650
2690	14H-20F-X7-0-R	BROWN PETER G & THOMAS	281-4 ORLEANS RD	PO BOX 483	N CHATHAM	MA	02650-0483
2691	14H-20G-X8-0-R	ROSS CAROLYN L	281-5 ORLEANS RD	PO BOX 473	N CHATHAM	MA	02650-0473
2743	14H-TOY-BOX-0-E	ENTERPRISE DR NOMINEE TRUST	135 ENTERPRISE DR	155 CROWELL RD	CHATHAM	MA	02633
7908	14H-HYTD-CON-0-E	HYTIDE CONDO ASSOCIATION	0 ORLEANS RD		10 10 MA SEATH		
8445	14H-NCHA-VILL-0-E	NORTH CHATHAM VILLAGE CONDO	0 MISTY MEADOW LN	0 MISTY MEADOW LN	CHATHAM	MA	02633
2812	14I-5-5-0-R	WATSON SHAYNE N	362 ORLEANS RD	362 ORLEANS RD	N CHATHAM	MA	02650
10920000	14I-6-6-0-R	BAILEY RICHARD K JR	350 ORLEANS RD	19 RIVER RD	ORLEANS	MA	02653
2818	14I-7-23-0-R	DOANE THOMAS L & LINDA L	11 OLD MAIL RD	PO BOX 1322	W CHATHAM	MA	02669-1322
WELDOWN.					N CHATHAM	MA	02650
	14I-8-24-0-R	MCINTIRE KENNETH A & MOLLY T/E	25 OLD MAIL RD	25 OLD MAIL RD			
2820	14I-9-21-0-R	HILDEBRANDT JONATHAN H & MARY L	31 OLD MAIL RD	385 HANOVER ST	HANOVER	MA	02339
2778	14I-31-AC3-0-R	THE ROSKEY FAMILY TRUST FUND ROSKEY SEAN T & FLORENCE A TRUSTEE	36 OLD MAIL RD	135 MARKET ST APT B	PORTSMOUTH	NH	03801
2779	14I-32-AC2-0-R	MARSDEN PETER V & MARY ELLEN	26 OLD MAIL RD	9 SILVER BIRCH LN	LINCOLN	MA	01773
2781	14I-33-A1-0-R	HOLLYDENE LLC	330 ORLEANS RD	330 ORLEANS RD	N CHATHAM	MA	02650
2782	14I-34-A2-0-R	GALLAGHER DEREK & RYAN CARLA J/T wf	320 ORLEANS RD	5C ALBION PL	CHARLESTOWN	MA	02129
2783	14I-35-A4-0-R	HEFERNAN DAVID & MARIA	314 ORLEANS RD	9 MEADOWOOD LN	E FALMOUTH	MA	02536-6267
2784	14I-36-A5-0-R	MELDON JOHN J TRUSTEE N CHATHAM BUILD RE TRUST	300 ORLEANS RD	60 N WATER ST	NEW BEDFORD	MA	02740
2785	14I-37-A7-0-R	MCGUIRE KATHLEEN & PAUL CROOK	294 ORLEANS RD	26 HINCKLEY ST #1	DORCHESTER	MA	02125
2795	14I-40-15-0-R	PAONE ERIC	303 ORLEANS RD	PO BOX 824	N CHATHAM	MA	02650
2796	14I-41-14A-0-R	FRANKEL O'KEEFE, LLC	323 ORLEANS RD	323 ORLEANS RD	N CHATHAM	MA	02650
2797	14I-42-16B-0-R	PAONE ERIC	0 MISTY MEADOW LN	PO BOX 824	N CHATHAM	MA	02650
2798	14I-44-8-0-R	SORBELLO ALFRED M & ELIZABETH M C/O SORBELLO TRUST	347 ORLEANS RD	28 LADY SLIPPER LN	MARSTON MILLS	MA	02648
2780	14I-32A-AC1-0-R	MARSDEN PETER & MARY ELLEN	0 OLD MAIL RD	9 SILVER BIRCH LN	LINCOLN	MA	01773
2788	14I-38A-N22-0-R	MAGIERA PHILLIP & SERAFINO JACQUELII	35 SPRING HILL RD	35 SPRING HILL RD	N CHATHAM DO TO	MA	02650
2789	14I-38B-N23-0-R	LYONS MARK E & NANCY C PAULSEN T/E	55 SPRING HILL RD	55 SPRING HILL RD	N CHATHAM	MA	02650
2799	14I-45A-XAA-0-R	FOUGERE LEONARD L & DOROTHY G	367-A ORLEANS RD	367A ORLEANS RD	N CHATHAMUI 2	7MA)	02650-1182
2800		CHRISTOPHER NEILL KIDD 1/2	367-B ORLEANS RD	11 FARMS END RD	WAPPINGERS FALLS	NY	12590
2801		JEFFREY P KIDD 1/2 BLAKE VIVIENNE A		367 ORLEANS RD APT C	N.CHATHAM/N OF		02650
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Key	Parcel ID	Owner	Location	Mailing Street	Mailing City	ST	ZipCd/Country
2802	14I-45D-XAD-0-R	STRETTON JOANNE	367-D ORLEANS RD	35 BENEDICT RD	BETHEL	СТ	06801
2803	14I-46A-XBA-0-R	JUDITH T DOE LIVING TRUST JUDITH T DOE TRSUTEE	369-A ORLEANS RD	369A ORLEANS RD	N CHATHAM	MA	02650
2804	14I-46B-XBB-0-R	PEIRCE ANNE M	369-B ORLEANS RD	369 ORLEANS RD #B	N CHATHAM	MA	02650
2805	14I-46C-XBC-0-R	THOMAS A CALLAHAN REV TRUST MARION E CALLAHAN TRUSTEE	369-C ORLEANS RD	633 NEWTON ST	S HADLEY	MA	01075
2806	14I-46D-XBD-0-R	YASSAMAN JOHN MARY DUPAY	369-D ORLEANS RD	PO BOX 3278	NAPLES	FL	34106
2807	14I-46E-XBE-0-R	CHRISTIANSEN XENIA A	369-E ORLEANS RD	369-E ORLEANS RD	N CHATHAM	MA	02650
7909	14I-RYD-HOL-0-E	RYDER HOLLOW CONDO ASSOCIATION	0 ORLEANS RD				



13H-4B-X2-0-R

13H-4C-X3-0-R

FERLITA JANET APT 1 36 MISTY MEADOW LN N CHATHAM, MA 02650 DUARTE HEATHER PO BOX 64 N CHATHAM, MA 02650-0064 REDMOND THOMAS A PO BOX 475 N CHATHAM, MA 02650

13H-4D-X4-0-R

13H-4E-X5-0-R

13H-4F-X6-0-R

TAVALONE PAUL J 76 QUAKER LN BOLTON, MA 01740 WEBSTER EDMUND JR & ABIGAIL DOHERT NANCY NOMINEE TRUST PO BOX 75 CHATHAM, MA 02633

HAMMOND JANE 12 JUNIPER DR MASHPEE, MA 02649-2146

13H-4G-X7-0-R

13H-4H-X8-0-R

13H-PORT-VLG1-0-E

ANDERSON RITA M 44 MISTY MEADOW LN #7 N CHATHAM, MA 02650 HOWARD ROBERT F III & CECILIA B 136 POWDER HILL RD BEDORD, NH 03110 PORTSIDE VILLAGE CONDO 1 0 MISTY MEADOW LN CHATHAM, MA 02633

14H-20-19-0-R

14H-20-X1-0-R

14H-23-AB-0-R

COLONIAL GAS CO DBA NATIONAL GRID PROPERTY TAX DEPT 40 SYLVAN RD WALTHAM, MA 02451

MILLER JOHN PO BOX 79 S CHATHAM, MA 02659-0079 293 ORLEANS ROAD LLC 17 BUCKINGHAM ST CAMBRIDGE, MA 02138

14H-61-X37A-0-R

14H-61-X37B-0-R

14H-61-X39-0-R

DOYLE STEPHEN HD & BRIDGET K 6 CHATHAM WAY S HADLEY, MA 01075 ALAIMO JAMES J JR PO BOX 1120 ENFIELD, CT 06083-1120 KONOPKA JOAN PO BOX 103 CHATHAM, MA 02633

14H-61-X41A-0-R

14H-61-X41B-0-R

14H-61-X43A-0-R

HUFNAGEL JAMES M & PAMELA S 49 GEORGETOWN CT BASKING RIDGE, NJ 07920 STAMP WILLIAM J & HEIDI A 41-B MISTY MEADOW LN N CHATHAM, MA 02650 43A MISTY MEADOW LN REALTY TRUST THOMAS P KING JR TRUSTEE 14 WALNUT HILL DR SCITUATE, MA 02066

14H-61-X43B-0-R

14H-68-XA-0-R

14H-68-XB-0-R

MAZZER THOMAS C & MARIA C 43B MISTY MEADOW LN N CHATHAM, MA 02650-1138

SWENSON PETER E TR SWENSON JUDITH L TR 1370 MAIN ST CHATHAM, MA 02633

PETER E & JUDITH L SWENSON TRUSTS 1370 MAIN ST CHATHAM, MA 02633

14H-68-XC-0-R

14H-68-XD-0-R

14H-68-XE-0-R

FLOCCO THOMAS J 256 SHERIDAN RD WINNETKA, IL 60093 LONGERSTAEY JACQUES M IPEKDJIAN DIANA N 2209 WRENWOOD PONT CT CHARLOTTE, NC 28211-1800

TISQUANTUM ROAD LLC 109 TISQUANTUM ROAD CHATHAM, MA 02633

14H-20A-X2-0-R

14H-20B-X3-0-R

14H-20C-X4-0-R

BOBER MATTHEW D & NANCY D 44 NONANTUM LN CHATHAM, MA 02633

279 ORLEANS RD LLC STEPHEN W WILLIAMS 279 ORLEANS RD N CHATHAM, MA 02650

BOYLE KEVIN M & ELLEN WRAGA 3 D APPLEWOOD DR BALLSTON LAKE, NY 12019

14H-20D-X5-0-R

14H-20E-X6-0-R

14H-20F-X7-0-R

ERENO RODRIGO PO BOX 281 SOUTH CHATHAM, MA 02659 OCONNELL THOMAS R 281 ORLEANS UNIT 3 N CHATHAM, MA 02650 BROWN PETER G & THOMAS PO BOX 483 N CHATHAM, MA 02650-0483 ROSS CAROLYN L PO BOX 473 N CHATHAM, MA 02650-0473 ENTERPRISE DR NOMINEE TRUST 155 CROWELL RD CHATHAM, MA 02633 HYTIDE CONDO ASSOCIATION

14H-NCHA-VILL-0-E

14I-5-5-0-R

14I-6-6-0-R

NORTH CHATHAM VILLAGE CONDO 0 MISTY MEADOW LN CHATHAM, MA 02633 WATSON SHAYNE N 362 ORLEANS RD N CHATHAM, MA 02650 BAILEY RICHARD K JR 19 RIVER RD ORLEANS, MA 02653

14I-7-23-0-R

14I-8-24-0-R

14I-9-21-0-R

DOANE THOMAS L & LINDA L PO BOX 1322 W CHATHAM, MA 02669-1322 MCINTIRE KENNETH A & MOLLY T/E 25 OLD MAIL RD N CHATHAM, MA 02650 HILDEBRANDT JONATHAN H & MARY L 385 HANOVER ST HANOVER, MA 02339

14I-31-AC3-0-R

14I-32-AC2-0-R

14I-33-A1-0-R

THE ROSKEY FAMILY TRUST FUND ROSKEY SEAN T & FLORENCE A TRUSTEE: 135 MARKET ST APT B PORTSMOUTH, NH 03801

MARSDEN PETER V & MARY ELLEN 9 SILVER BIRCH LN LINCOLN, MA 01773 HOLLYDENE LLC 330 ORLEANS RD N CHATHAM, MA 02650

14I-34-A2-0-R

14I-35-A4-0-R

14I-36-A5-0-R

GALLAGHER DEREK & RYAN CARLA J/T wR 5C ALBION PL CHARLESTOWN, MA 02129 HEFERNAN DAVID & MARIA 9 MEADOWOOD LN E FALMOUTH, MA 02536-6267 MELDON JOHN J TRUSTEE N CHATHAM BUILD RE TRUST 60 N WATER ST NEW BEDFORD, MA 02740

14I-37-A7-0-R

14I-40-15-0-R

14I-41-14A-0-R

MCGUIRE KATHLEEN & PAUL CROOK 26 HINCKLEY ST #1 DORCHESTER, MA 02125 PAONE ERIC PO BOX 824 N CHATHAM, MA 02650 FRANKEL O'KEEFE, LLC 323 ORLEANS RD N CHATHAM, MA 02650

14I-42-16B-0-R

14I-44-8-0-R

14I-32A-AC1-0-R

PAONE ERIC PO BOX 824 N CHATHAM, MA 02650 SORBELLO ALFRED M & ELIZABETH M C/O SORBELLO TRUST 28 LADY SLIPPER LN MARSTON MILLS, MA 02648

MARSDEN PETER & MARY ELLEN 9 SILVER BIRCH LN LINCOLN, MA 01773

14I-38A-N22-0-R

14I-38B-N23-0-R

14I-45A-XAA-0-R

MAGIERA PHILLIP & SERAFINO JACQUELIN 35 SPRING HILL RD N CHATHAM, MA 02650 LYONS MARK E & NANCY C PAULSEN T/E 55 SPRING HILL RD N CHATHAM, MA 02650 FOUGERE LEONARD L & DOROTHY G 367A ORLEANS RD N CHATHAM, MA 02650-1182

14I-45B-XAB-0-R

14I-45C-XAC-0-R

14I-45D-XAD-0-R

CHRISTOPHER NEILL KIDD 1/2 JEFFREY P KIDD 1/2 11 FARMS END RD WAPPINGERS FALLS, NY 12590

BLAKE VIVIENNE A 367 ORLEANS RD APT C N CHATHAM, MA 02650 STRETTON JOANNE 35 BENEDICT RD BETHEL, CT 06801

14I-46A-XBA-0-R

14I-46B-XBB-0-R

14I-46C-XBC-0-R

JUDITH T DOE LIVING TRUST JUDITH T DOE TRSUTEE 369A ORLEANS RD N CHATHAM, MA 02650

PEIRCE ANNE M 369 ORLEANS RD #B N CHATHAM, MA 02650 THOMAS A CALLAHAN REV TRUST MARION E CALLAHAN TRUSTEE 633 NEWTON ST S HADLEY, MA 01075 YASSAMAN JOHN MARY DUPAY PO BOX 3278 NAPLES, FL 34106 CHRISTIANSEN XENIA A 369-E ORLEANS RD N CHATHAM, MA 02650 RYDER HOLLOW CONDO ASSOCIATION



Bk 15302 Ps269 \$55856 06-26-2002 a 01:55p

Doc:876,683 06-26-2002 1:29 Ctf#:165726 BARNSTABLE LAND COURT REGISTRY <u>QUITCLAIM DEED</u>

Shooting Star Realty, LLC, a Massachusetts Limited Liability Company with a principal office at 323 Orleans Road, North Chatham, Massachusetts 02650,

for consideration in the amount of SEVEN HUNDRED THOUSAND AND 00/100 (\$700, 000.00) DOLLARS paid,

grants to

Frankel O'Keefe, LLC, a Massachusetts Limited Liability Company with a principal office at 323 Orleans Road, North Chatham, Massachusetts 02650,

with QUITCLAIM COVENANTS

The land in Chatham, Barnstable County, Massachusetts, described in EXHIBIT A attached hereto

PROPERTY ADDRESS: 323 ORLEANS ROAD, (NORTH) CHATHAM,

IN WITNESS WHEREOF, the said Shooting Star Realty, LLC has caused its seal to be hereto affixed and these presents to be signed in its name and behalf by Elizabeth M. Chiappetta, its Manager, this 25th day of June, 2002

Shooting Star Realty, LLC

By: Elizabeth M. Chiappetta, Manager

COMMONWEALTH OF MASSACHUSETTS

Suffolk, ss

June 25, 2002

Then personally appeared the above-named Elizabeth M. Chiappetta, Manager and acknowledged the foregoing instrument to be the free act and deed of Shooting Star Realty, LLC, before me,

Notary Public NEAL & SATRAM

My commission expires:

CVER : 1

Exhibit "A"

Property Address: 323 Orleans Road N. Chatham, MA

Parcel I

A certain parcel of registered land, together with the buildings thereon, situated in Chatham, in the County of Barnstable and Commonwealth of Massachusetts, bounded and

Northeasterly

by the southwesterly line of the State Highway, one hundred five

Southeasterly

by Lot 15, one hundred thirty-one and 17/100 (131.17) feet;

Westerly

by a portion of land now or formerly of the Town of Chatham, one

hundred seventy-six and 28/100 (176.28) feet; and

Northerly

by Lot 12, forty-nine and 83/100 (49.83) feet.

All of said boundaries are determined by the Court to be located as shown on subdivision plan 12310-G dated November 22, 1966, drawn by Nickerson & Berger, Surveyors, and filed in the Land Registration Office at Boston, a copy of which is filed in Barastable County Registry of Deeds in Land Registration Book 235, Page 49 with Certificate of Title No. 30309 and said land

Said lot is subject to the restrictions set forth in Document No. 80,760 Barnstable Registry District so far as now in force and applicable.

Said lot is subject to and has the benefit of the reservations, rights and restrictions set forth in Document No. 110,305.

For title to Parcel I, see Certificate of Title No. 161766

Parcel II

A certain parcel of unregistered land, together with the buildings thereon, situated in said Chatham, bounded and described as follows:

Northwesterly

by the sideline of Misty Meadow Lane, two hundred one and

90/100 (201.90) feet;

Easterly

by registered land, now or formerly Certificate No. 39455, one

hundred seventy-six and 28/100 (176.28) feet;

Southeasterly

by Lot 15, ninety-nine and 98/100 (99,98) feet; and

.

Southwesterly


by Lot 16, one hundred fifty-five (155) feet.


Containing an area of 23,526 square feet of land, more or less.

Said premises are shown as Lot 14 on plan of land entitled "Plan Showing Subdivision of Lot 13, Land Court Plan 12310F, Lot 13 of Plan recorded Barnstable Registry Book 181, Page 103 & Lot D, Plan for Nanly Homes Inc. Dated Nov. 1966, Land in Chatham, Mass. Scale 1" = 30' Nov. 22, 1966 Nickerson & Berger, Eng'rs. Eastham & Chatham", duly recorded with Barnstable County Registry of Deeds, unregistered land section, as Plan 216/105.

Subject to restrictions of record so far as the same may still be in force and applicable.

For title to Parcel II see deed in Book 13913, Page 134.

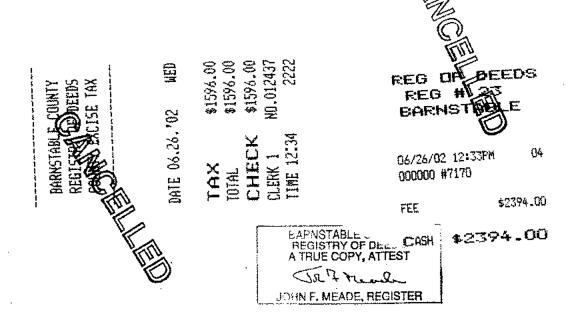

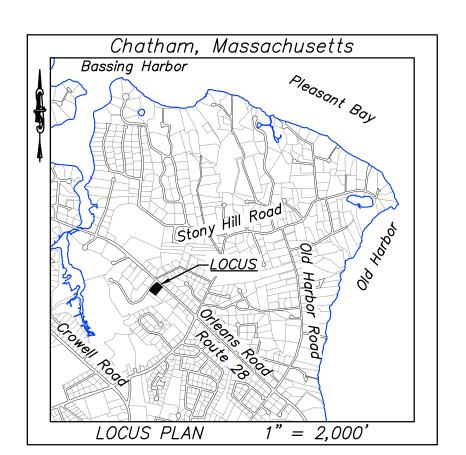

Assessors' ID: 141-41-14A

OWNER OF RECORD:

Frankel O'Keefe, LLC Deed Book 15,302, Page 269 Plan Book 216, Page 105, Lot 14 Certificate No. 165,726 L.C. Plan 12,310-G, Lot 14

ZONING REQUIREMENTS

Zone	<i>GB−3</i> ,	General	Business
Minimum Area		10,	.000 S.F.
Minimum Frontage)		100 Ft.
Front Yard Setbac	ck (Prir	nary)	50 Ft.
Front Yard Setbac	ck (Sec	ondary)	<i>30 Ft.</i>
Side and Rear Ya	rd Setb	pack	15 Ft.
Maximum Lot Cov	erage		60%
Maximum Building	Coverd	age	N/A
Required Green Ar	rea		40%
Front Parking Set	back		20 Ft.
Side Parking Setb	ack		15 Ft.

The features on the subject property were located with total station, GPS (geographic positioning system) and mobile LiDAR (light detection and ranging). The features depicted from these methods meet the requirements of 250 CMR. The features on the abutting properties are based on mobile LiDAR, aerial LiDAR and aerial photogrammetry. The features depicted from these methods meet the National Map Accuracy Standards.

Parking Spaces:

37 spaces, 2 handicapped spaces 40 spaces, 2 handicapped spaces Lot 10: 19 spaces

100 spaces

Proposed Parking Spaces:

50 spaces, 3 handicapped spaces 40 spaces, 2 handicapped spaces Lot 10: 19 spaces

114 spaces Total:

The striping on Lot 10 is worn and the spaces have been based on a 9' x 18' parking space. There are areas where parking is likely to the north of the Service Road but no spaces are delineated.

The utility locations are based on the following sources:

The overhead utilities are depicted as single lines running from located pole to located pole where there are multiple lines between the poles.

The underground natural gas is based on "Dig-Safe" markings.

The underground water is based partially on "Dig-Safe" markings and partially on the locations provided by the Town of Chatham Water Department.

The underground septic system is based on the visible manholes and on the measurements provided in a Title 5 Official Inspection Form dated 06-13-2016 prepared by James Ford for Stuart Rapp on file with the Town of Chatham Health Department.


The underground drainage system is based on the locations of the catch basin and exposed pipe with an estimated angle in between the two.

CHATHAM PLANNING BOARD

Date of Approva

X: \ARCHIVED DRAWINGS\4693 010 - Bierwirth, Frederick\4693 010 BIERWIRTH SITE 2017-07-11.dwg

Chairman

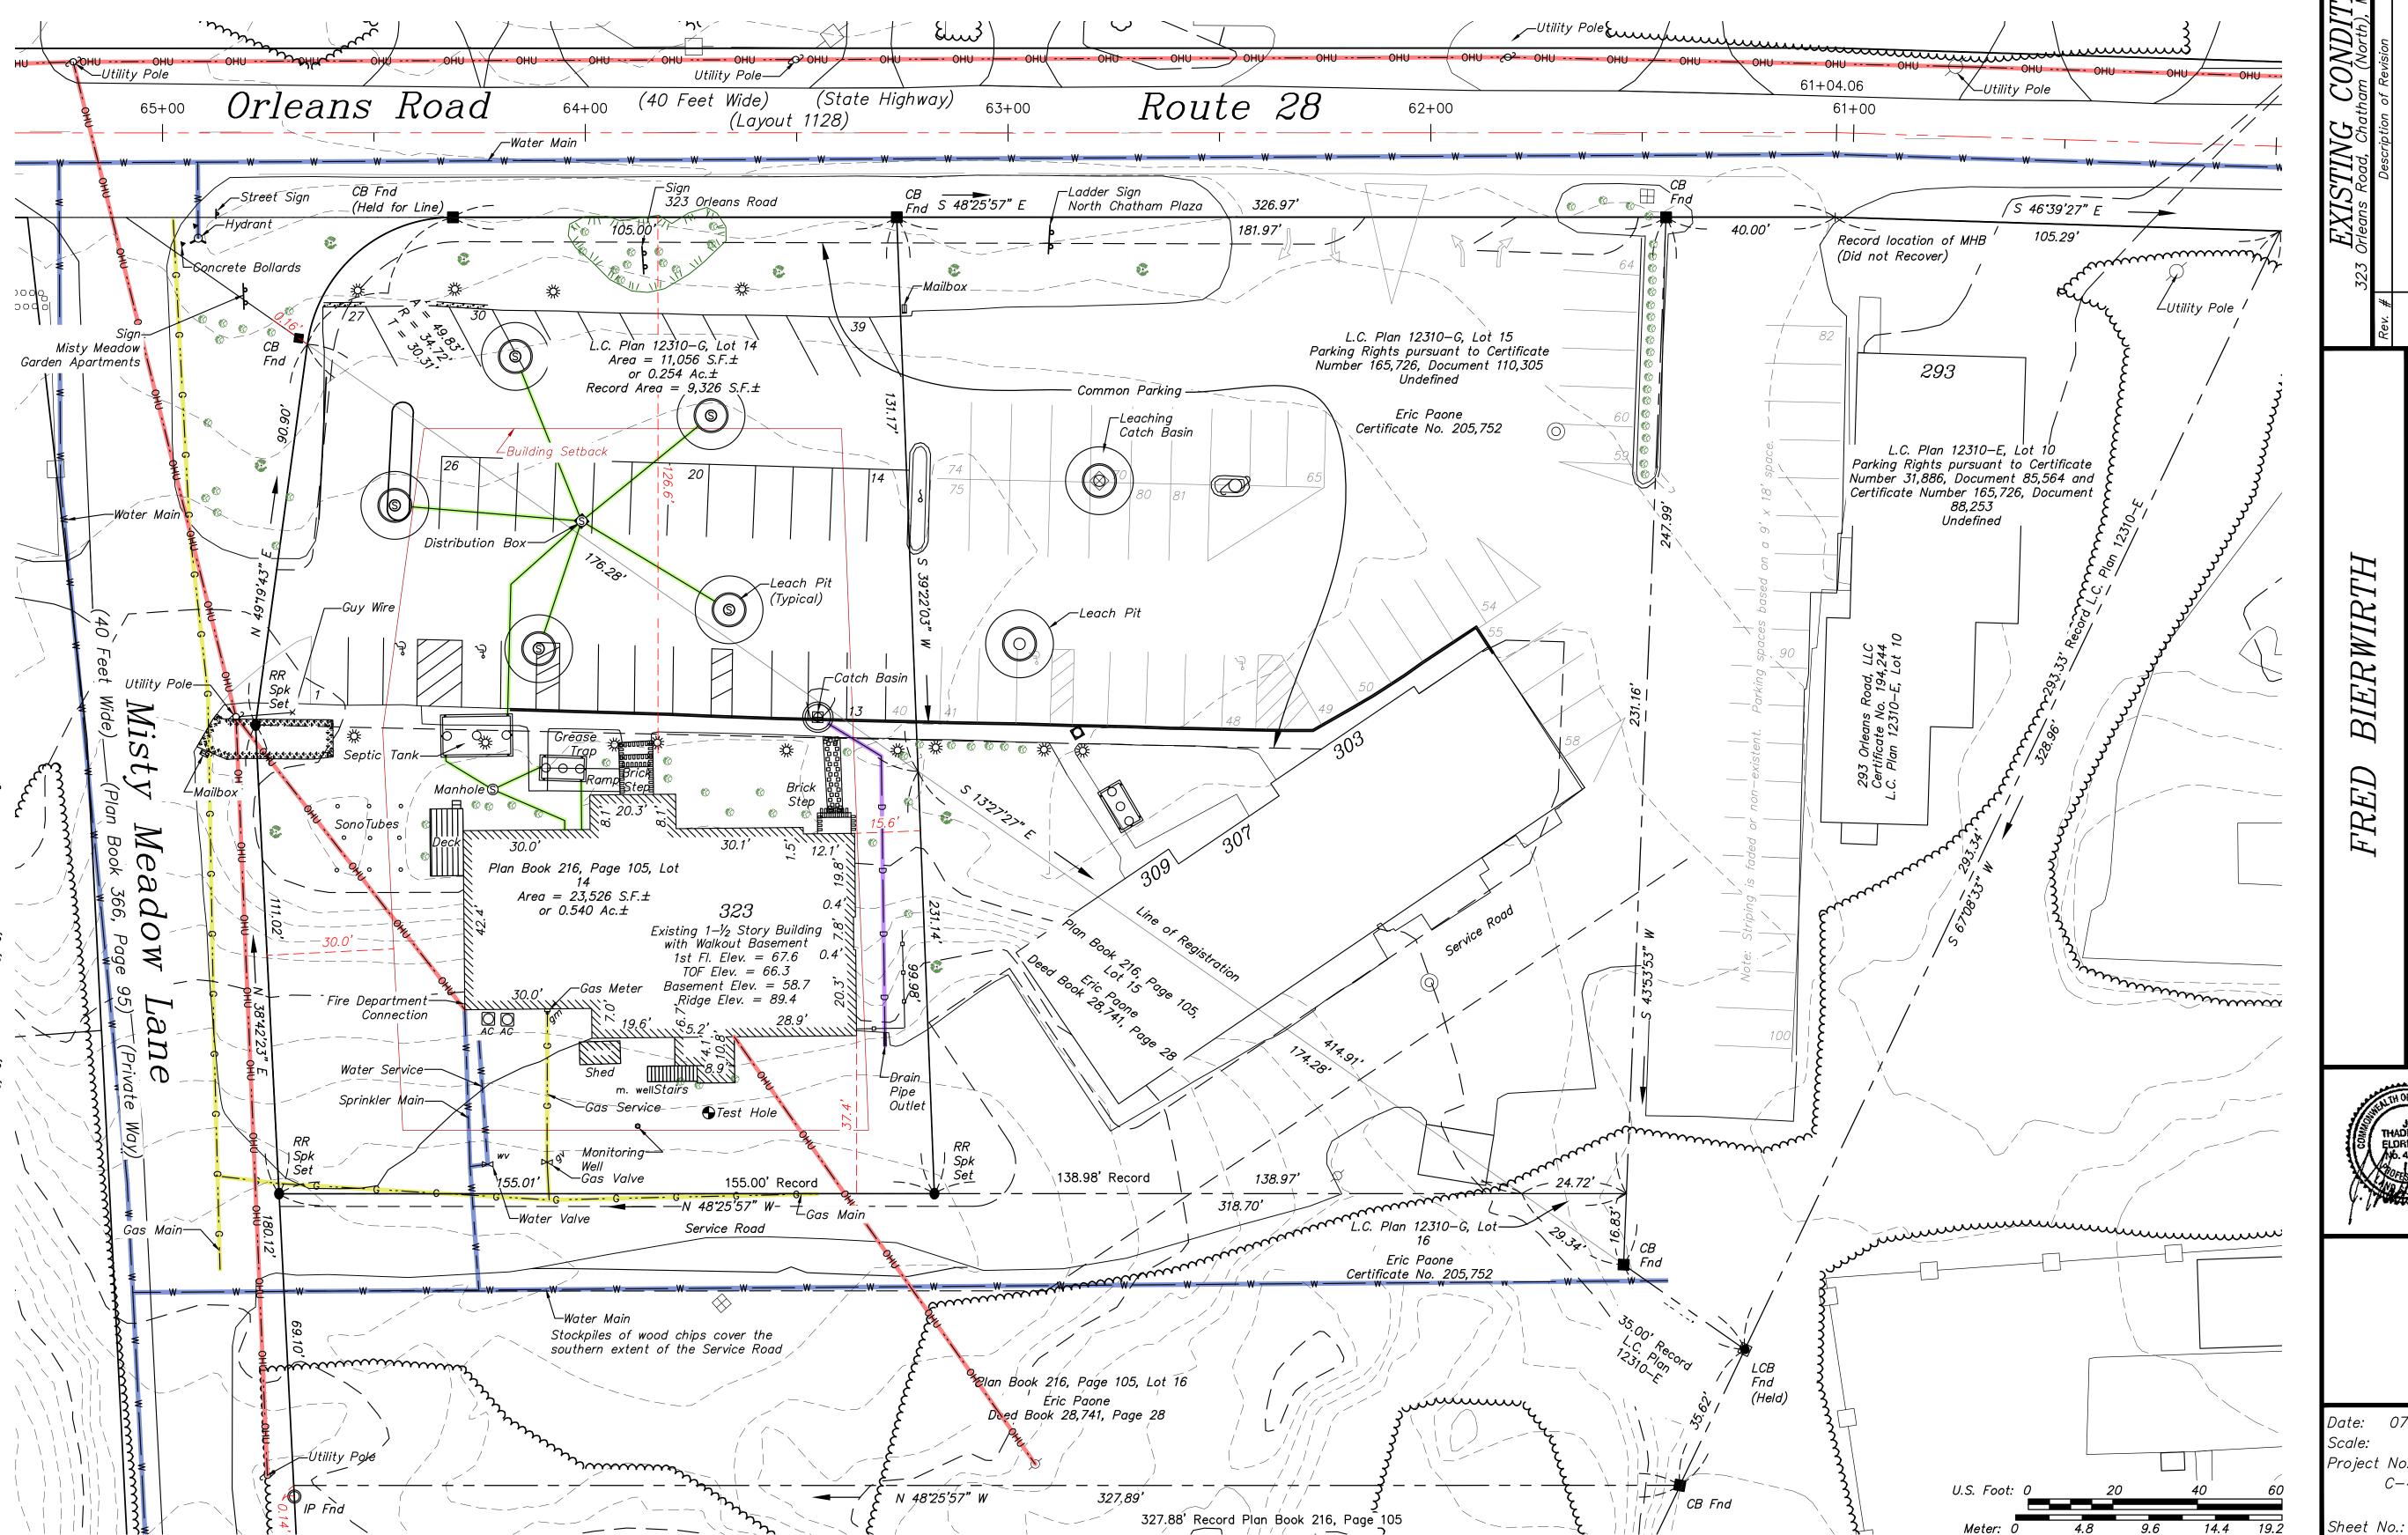




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Date: 07-24-2017 Scale: 1" = 20Project No.: C-4693-01.0

 $m{I}$ of

© Copyright 2017 by Eldredge Surveying & Engineering, LLC

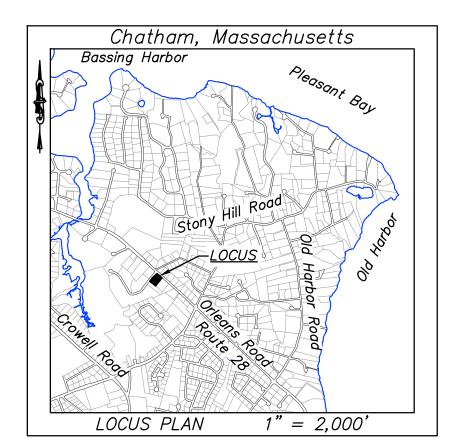

Assessors' ID: 141-41-14A

OWNER OF RECORD:

Frankel O'Keefe, LLC Deed Book 15,302, Page 269 Plan Book 216, Page 105, Lot 14 Certificate No. 165,726 L.C. Plan 12,310-G, Lot 14

Zoning Compliance Table								
Zone		GB-3 (G	eneral Business)					
	Existing Required Propos							
Lot Area	34,582 S.F.±	10,000 S.F.	34,582 S.F.±					
Buildable Upland	34,582 S.F.±	10,000 S.F.	34,582 S.F.±					
Frontage	306.92 Ft.	100 Ft.	306.92 Ft.					
Front Yard Setback (Primary)	136.5 Ft.	50 Ft.	128.0 Ft.					
Front Yard Setback (Secondary)	39.5 Ft.	30 Ft.	30.0 Ft.					
Side and Rear Yard Setback	15.6 Ft.	15 Ft.	15.6 Ft.					
Lot Coverage	23,357 S.F.±	20,749 S.F.	23,340 S.F.±					
or	67.5%	60%	67.5%					
Green Area	11,225 S.F.±	13,833 S.F.	11,250 S.F.±					
Front Parking Setback	10.2 Ft.	20 Ft.	10.2 Ft.					
Side Parking Setback	0 Ft.	15 Ft.	O Ft.					

Building				E	levation	1						Average
NORTH	65.8	+	65.3	+	65.2		=	196.3	1	3	=	65.4
EAST	65.2	+	58.6				=	123.8	1	2	=	61.9
SOUTH	57.4	+	56.7	+	57.8		=	171.9	1	3	=	57.3
WEST	59.5	+	66.0				=	125.5	1	2	=	62.8
									TC	T	٩L	247.4
247.4	/4 =							GRADE F	L	A١	ΝE	61.8
61.8	+ 30 =				MA:	MUMIX	RIE	OGE ELEV	A٦	ΓIC	NC	91.8
91.8	- Top of F	ou	ndation	1	66.3							25.5
	25.5		MAXII	ΜU	M HEIG	HT AB	ov	E TOP OF	F	O	UNE	NOITAC
91.8	- Ridge E	lev	ation		89.4						П	2.4
											C	OMPLIES
	EXISTING	G E	BUILDI	NG	HEIGH	IT.	П				П	27.6


Building				E	levation			Т	1	П	Average
NORTH	65.8	+	65.3	+	65.2	=	196.3	1	3	=	65.4
EAST	65.2	+	61.6			=	126.8	1	2	=	63.4
SOUTH	57.4	+	56.7	+	57.8	=	171.9	1	3	=	57.3
WEST	63.9	+	66.0			=	129.9	1	2	=	65.0
							T	0	ΓA	L	251.1
251.1	/4 =						GRADE P	LA	N	E	62.8
62.8	+ 30 =				MAX	MUM RI	DGE ELEV	٩TI	0	N	92.8
92.8	- Top of F	ou	ndation	1	66.3				1		26.5
	26.5		MAXII	ΜU	M HEIGH	IT ABOV	E TOP OF	FC	U	IND	ATION
92.8	- Ridge E	lev	ation		92.8				1		0.0
										C	OMPLIES
	PROPOS	EC	BUIL	DIN	IG HEIG	HT			٦	П	30.0

CHATHAM PLANNING BOARD

Date of Approval Chairman

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The total parking required by these calculations is 56 spaces. 53 spaces are provided which requires a waiver for the 3 spaces deficient. The basis of the waiver is twofold: first, the peak use times for the uses are not fully coincident. Fitness Centers have more traffic before and after the workday and Offices have more traffic during the workday. The second basis is that there are parking rights that extend into the two properties to the east.

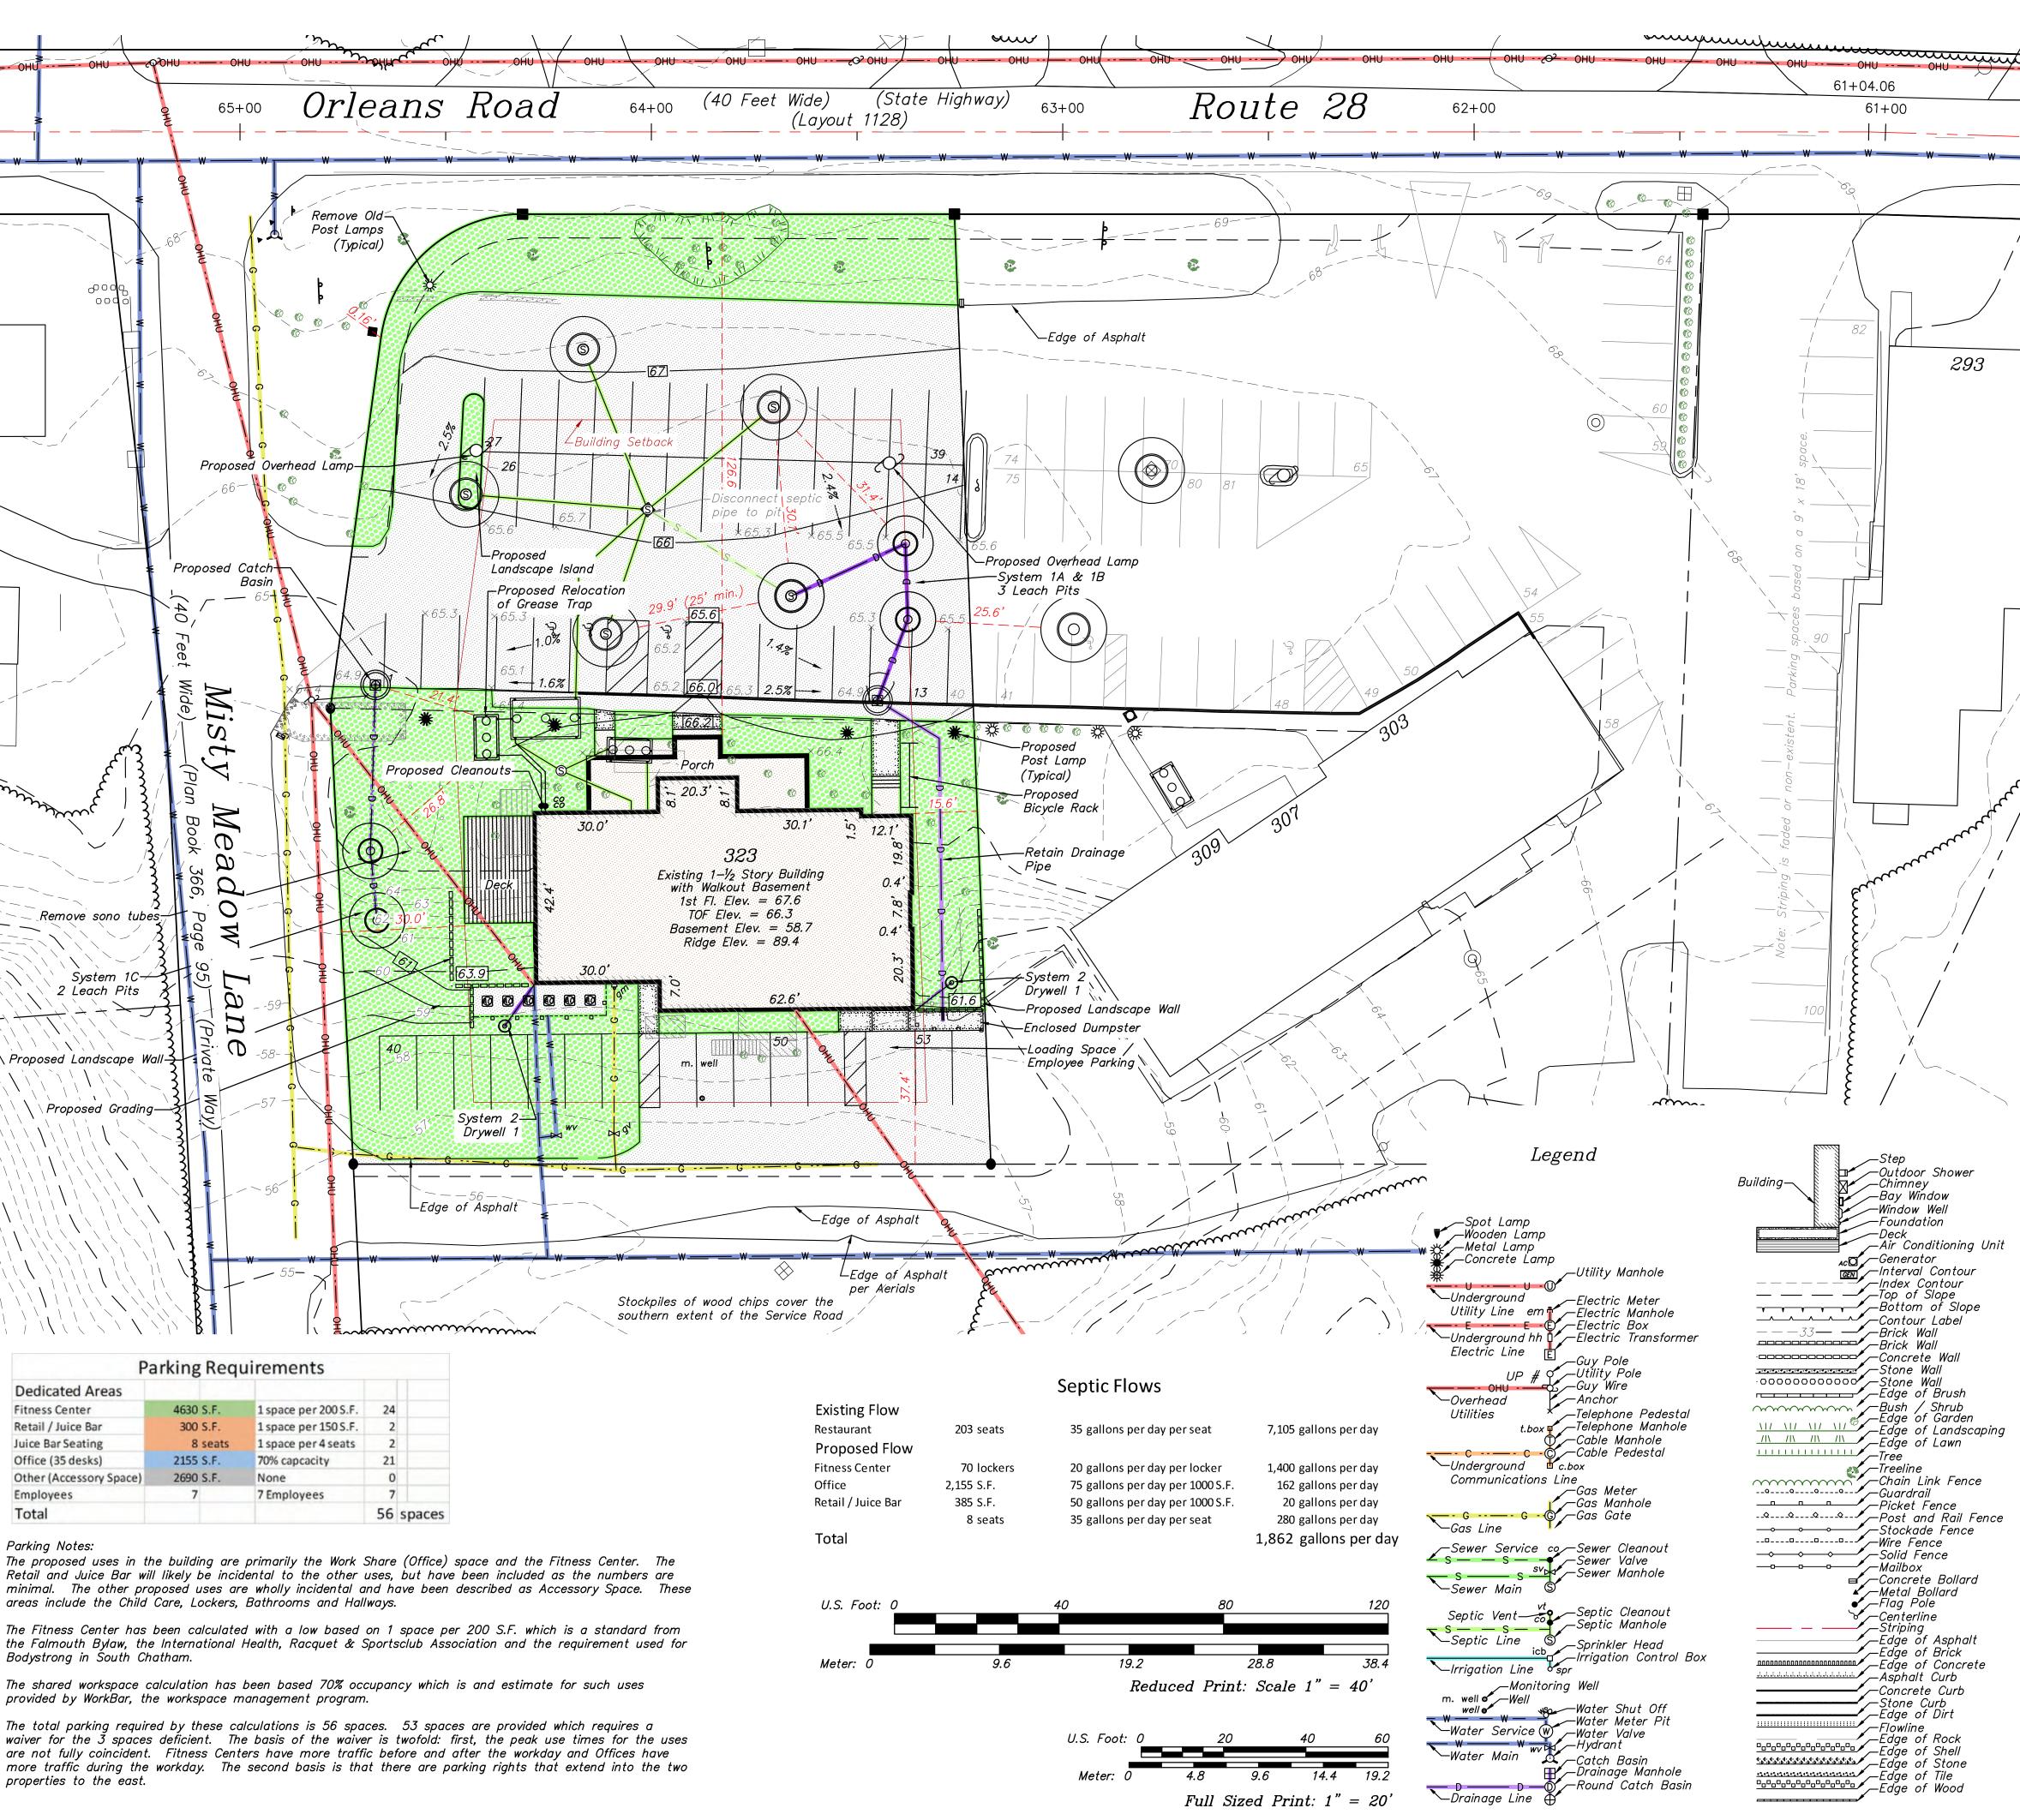

RKS,

THADDEUS ELDREDGE

Date: 07—24—2017

Scale:

X: \ARCHIVED DRAWINGS\4693 010 - Bierwirth, Frederick\4693 010 BIERWIRTH SITE 2017-07-11.dwg


Project No.:

Sheet No.:

1" = 20

C-4693-01.


2 of

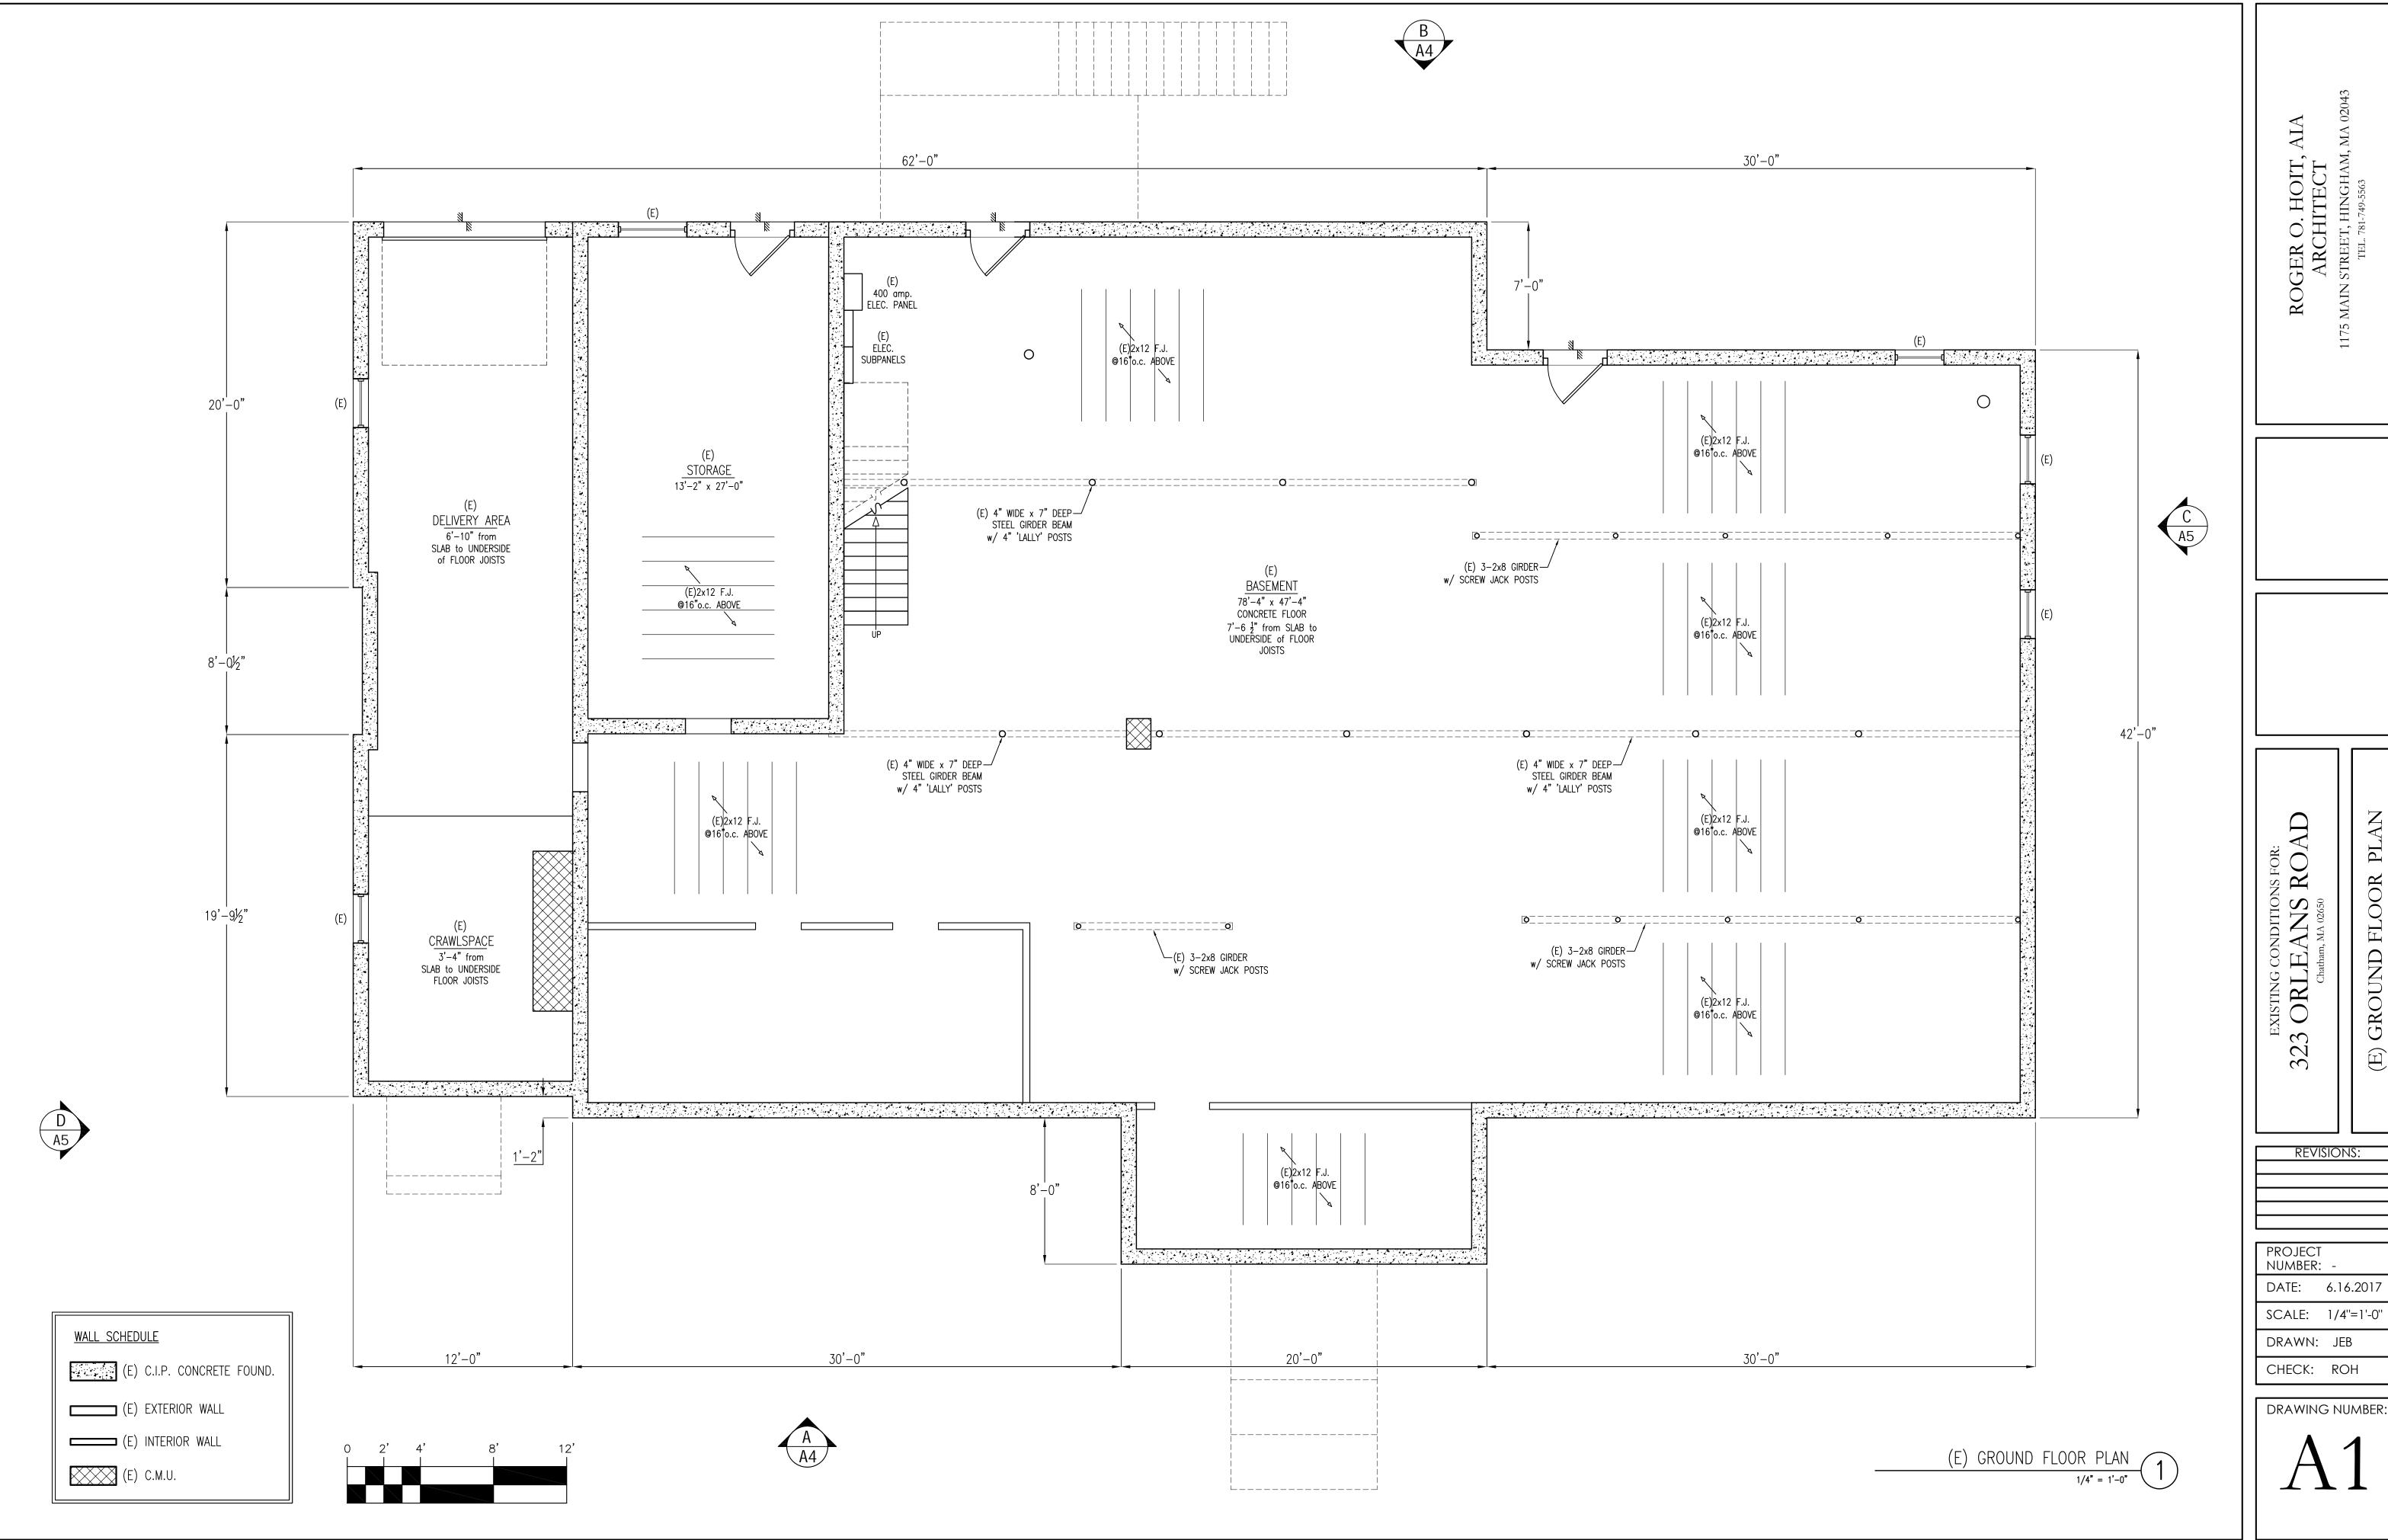


GROUND

REVISIONS:

DATE: 6.16.2017

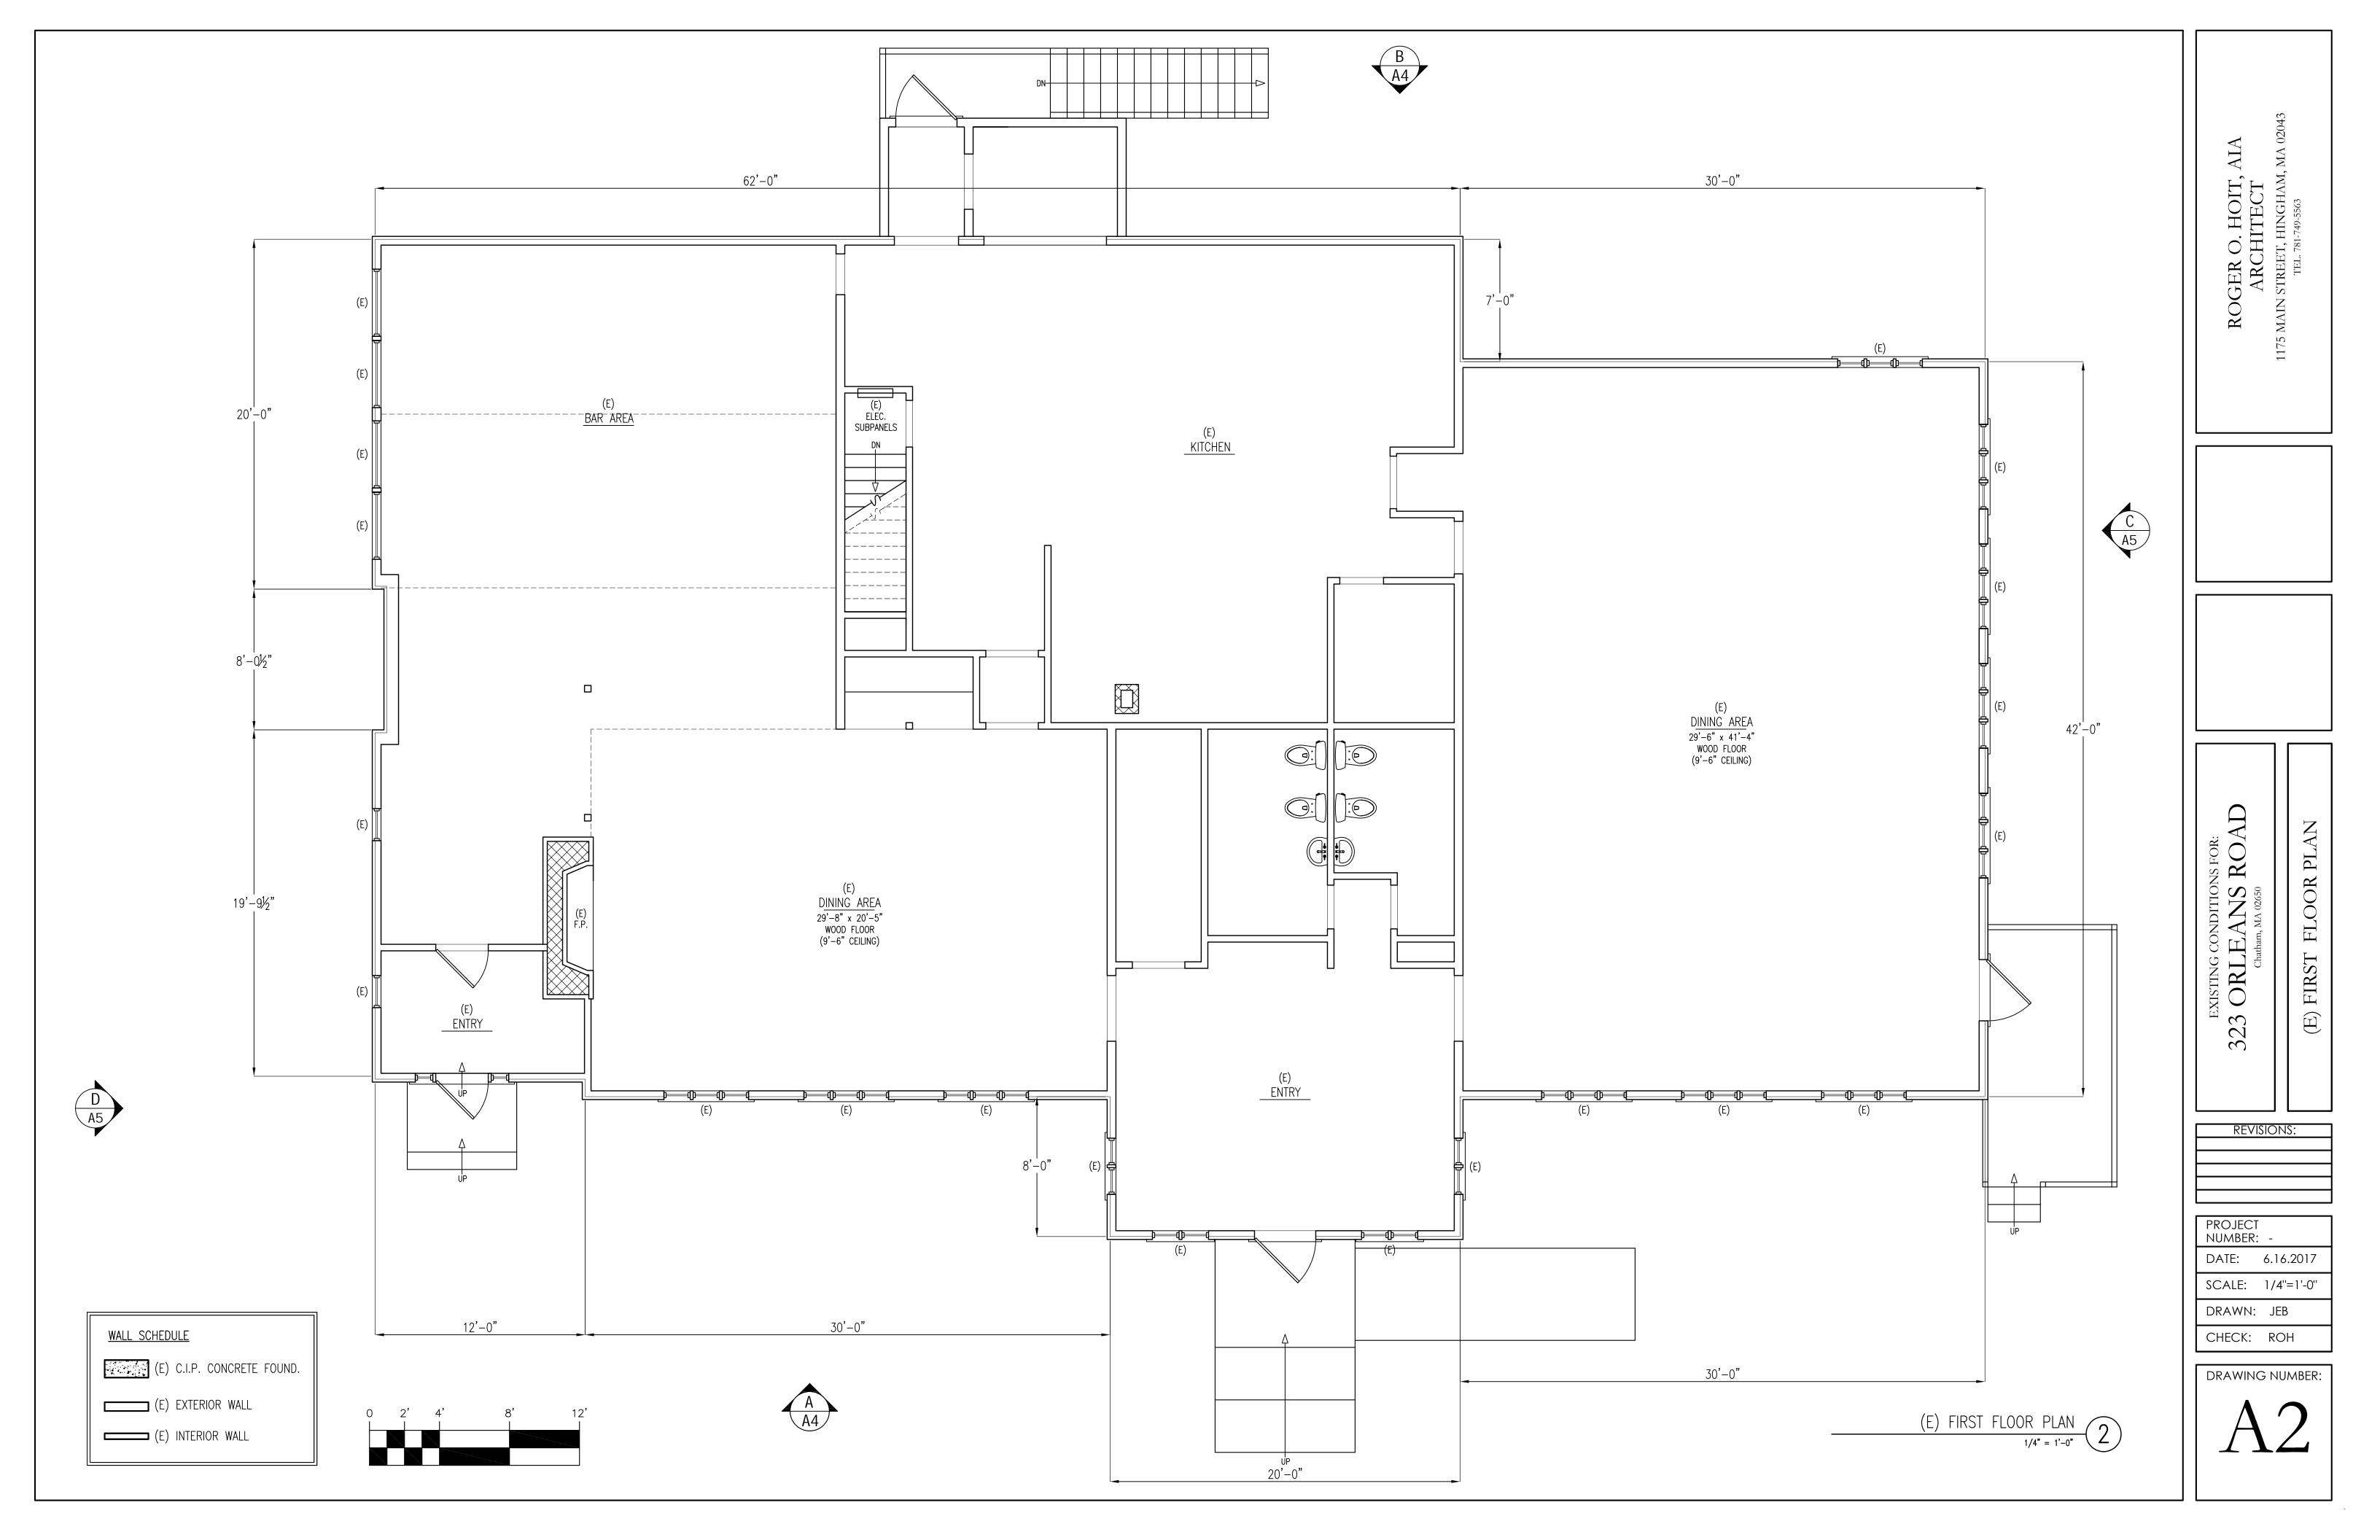

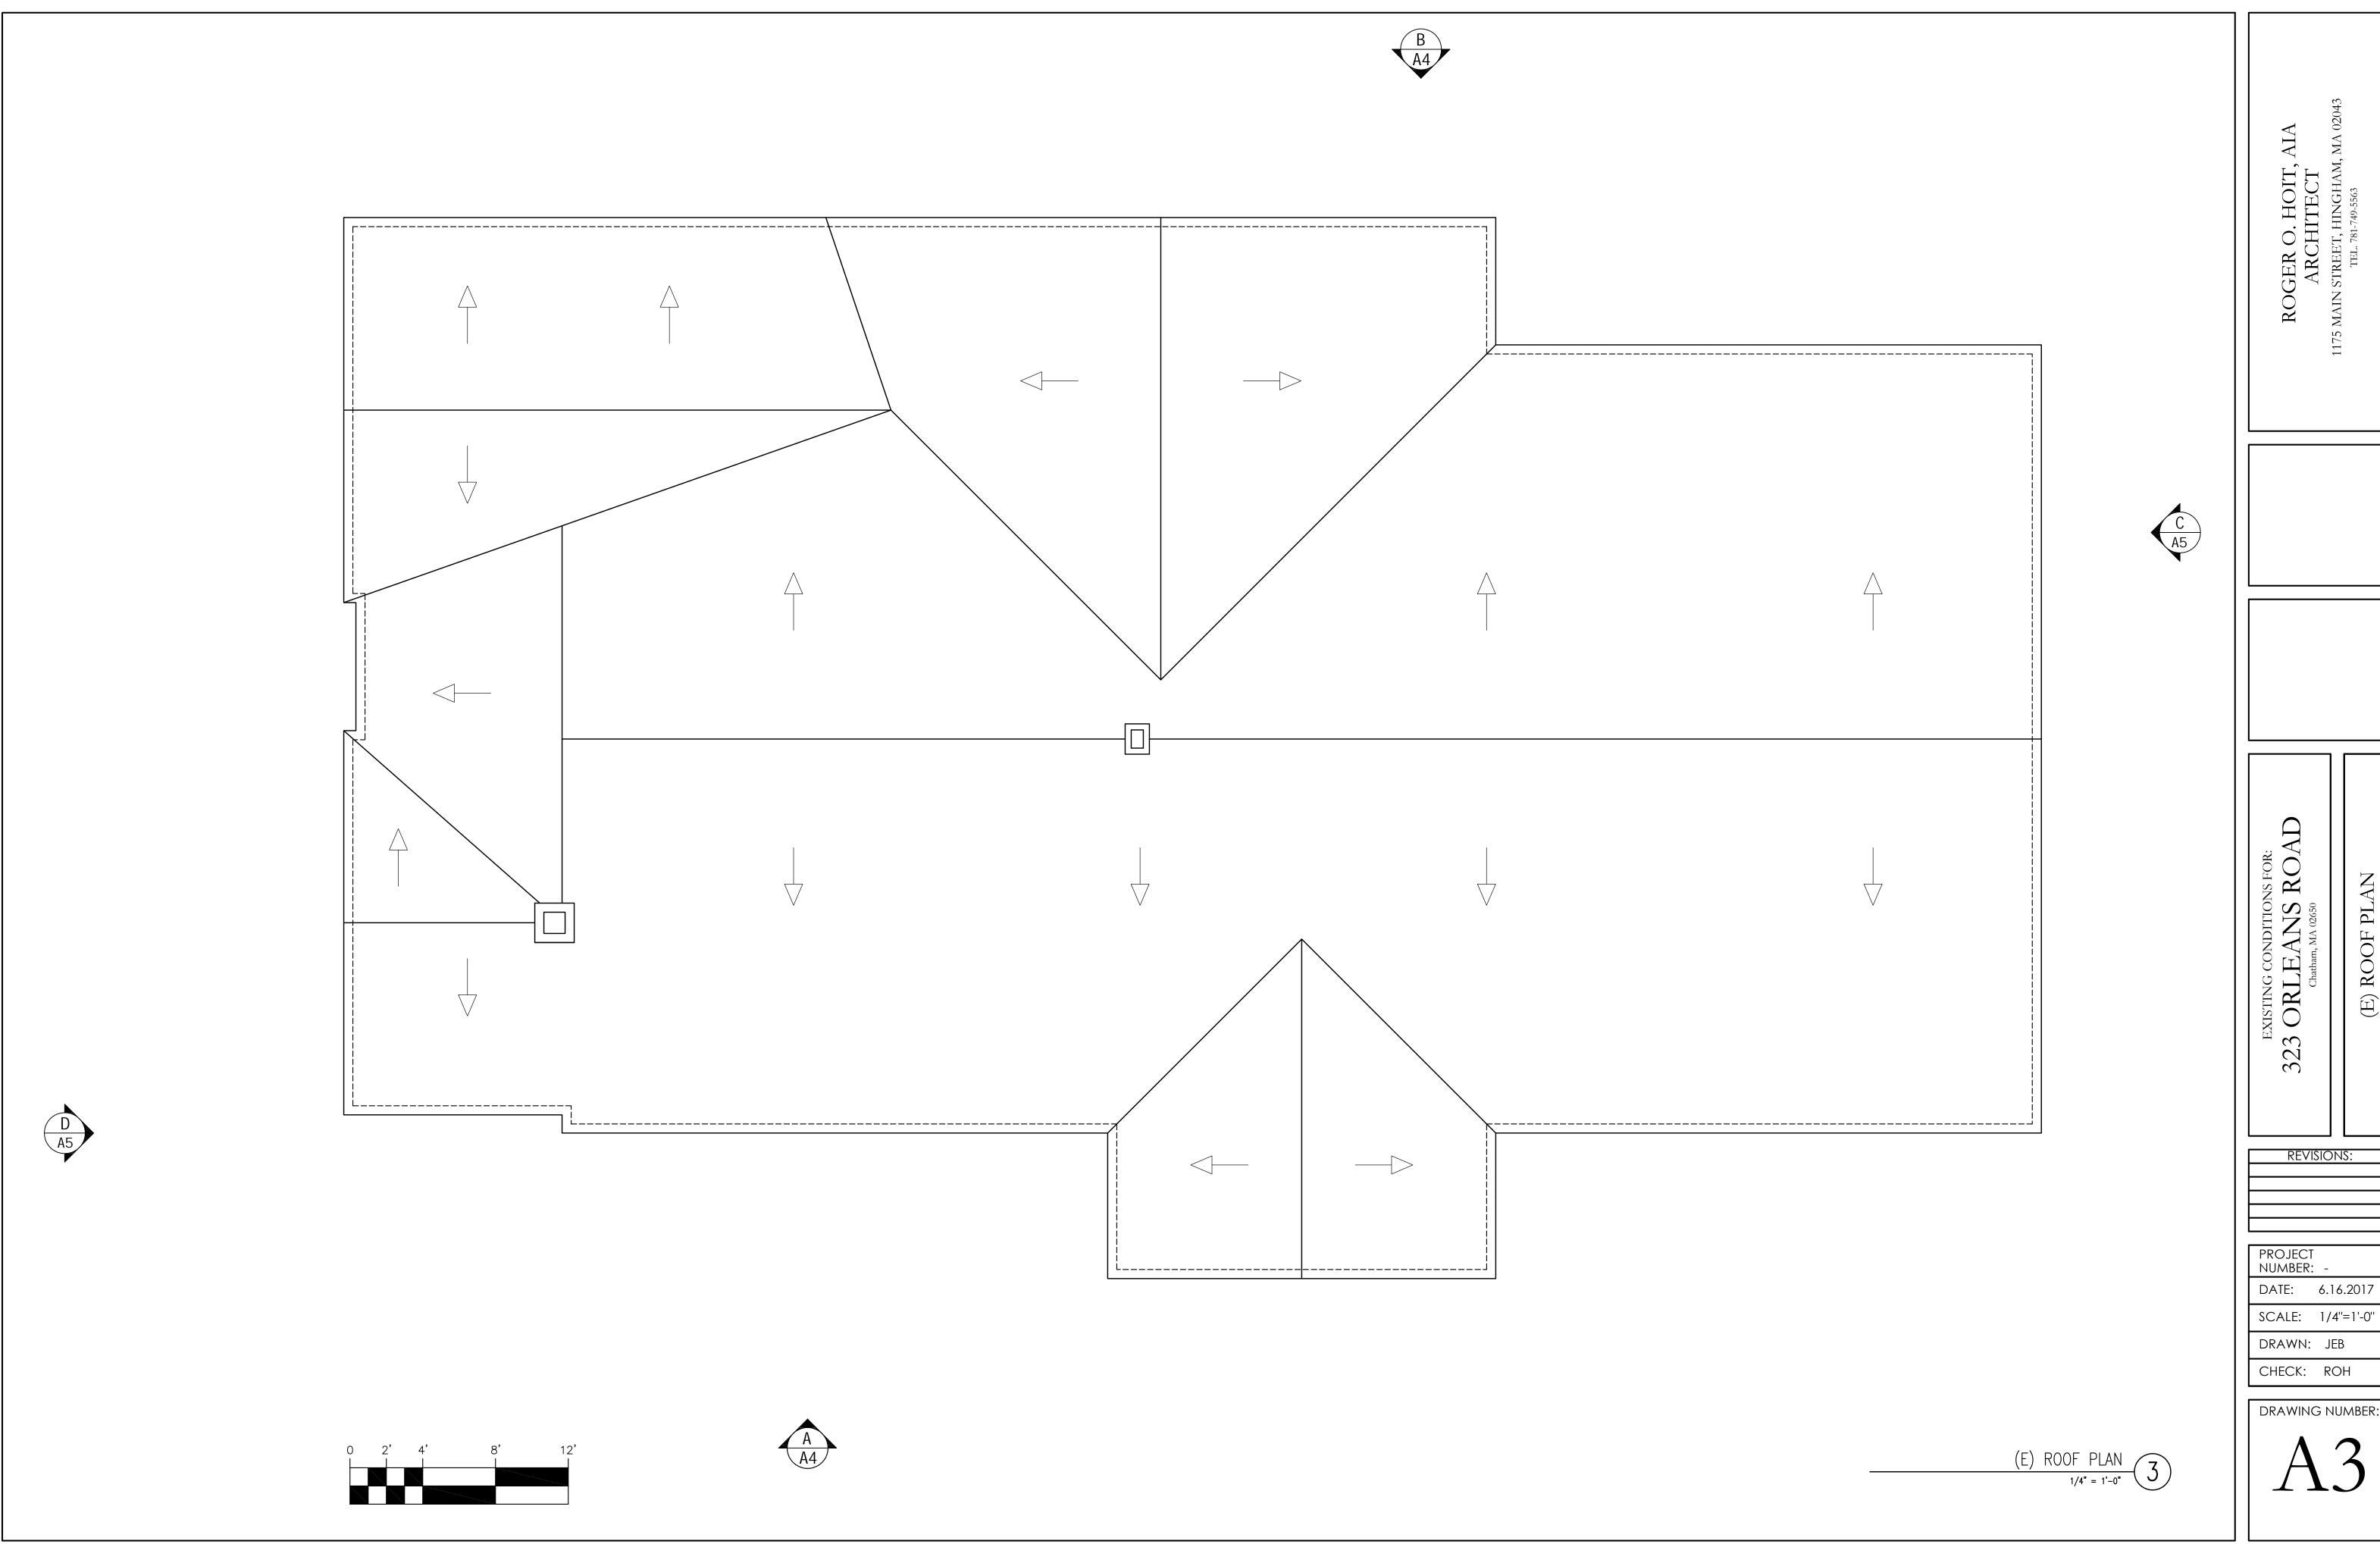

(E) ROOF PLA

REVISIONS:

PROJECT NUMBER: -DATE: 6.16.2017

DRAWN: JEB





NS FOR: ROAD (E) ELEVATIO

EXISTING CONDITIONS 323 ORLEANS F


revisions:


PROJECT NUMBER: -DATE: 6.16.2017


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CHECK: ROH





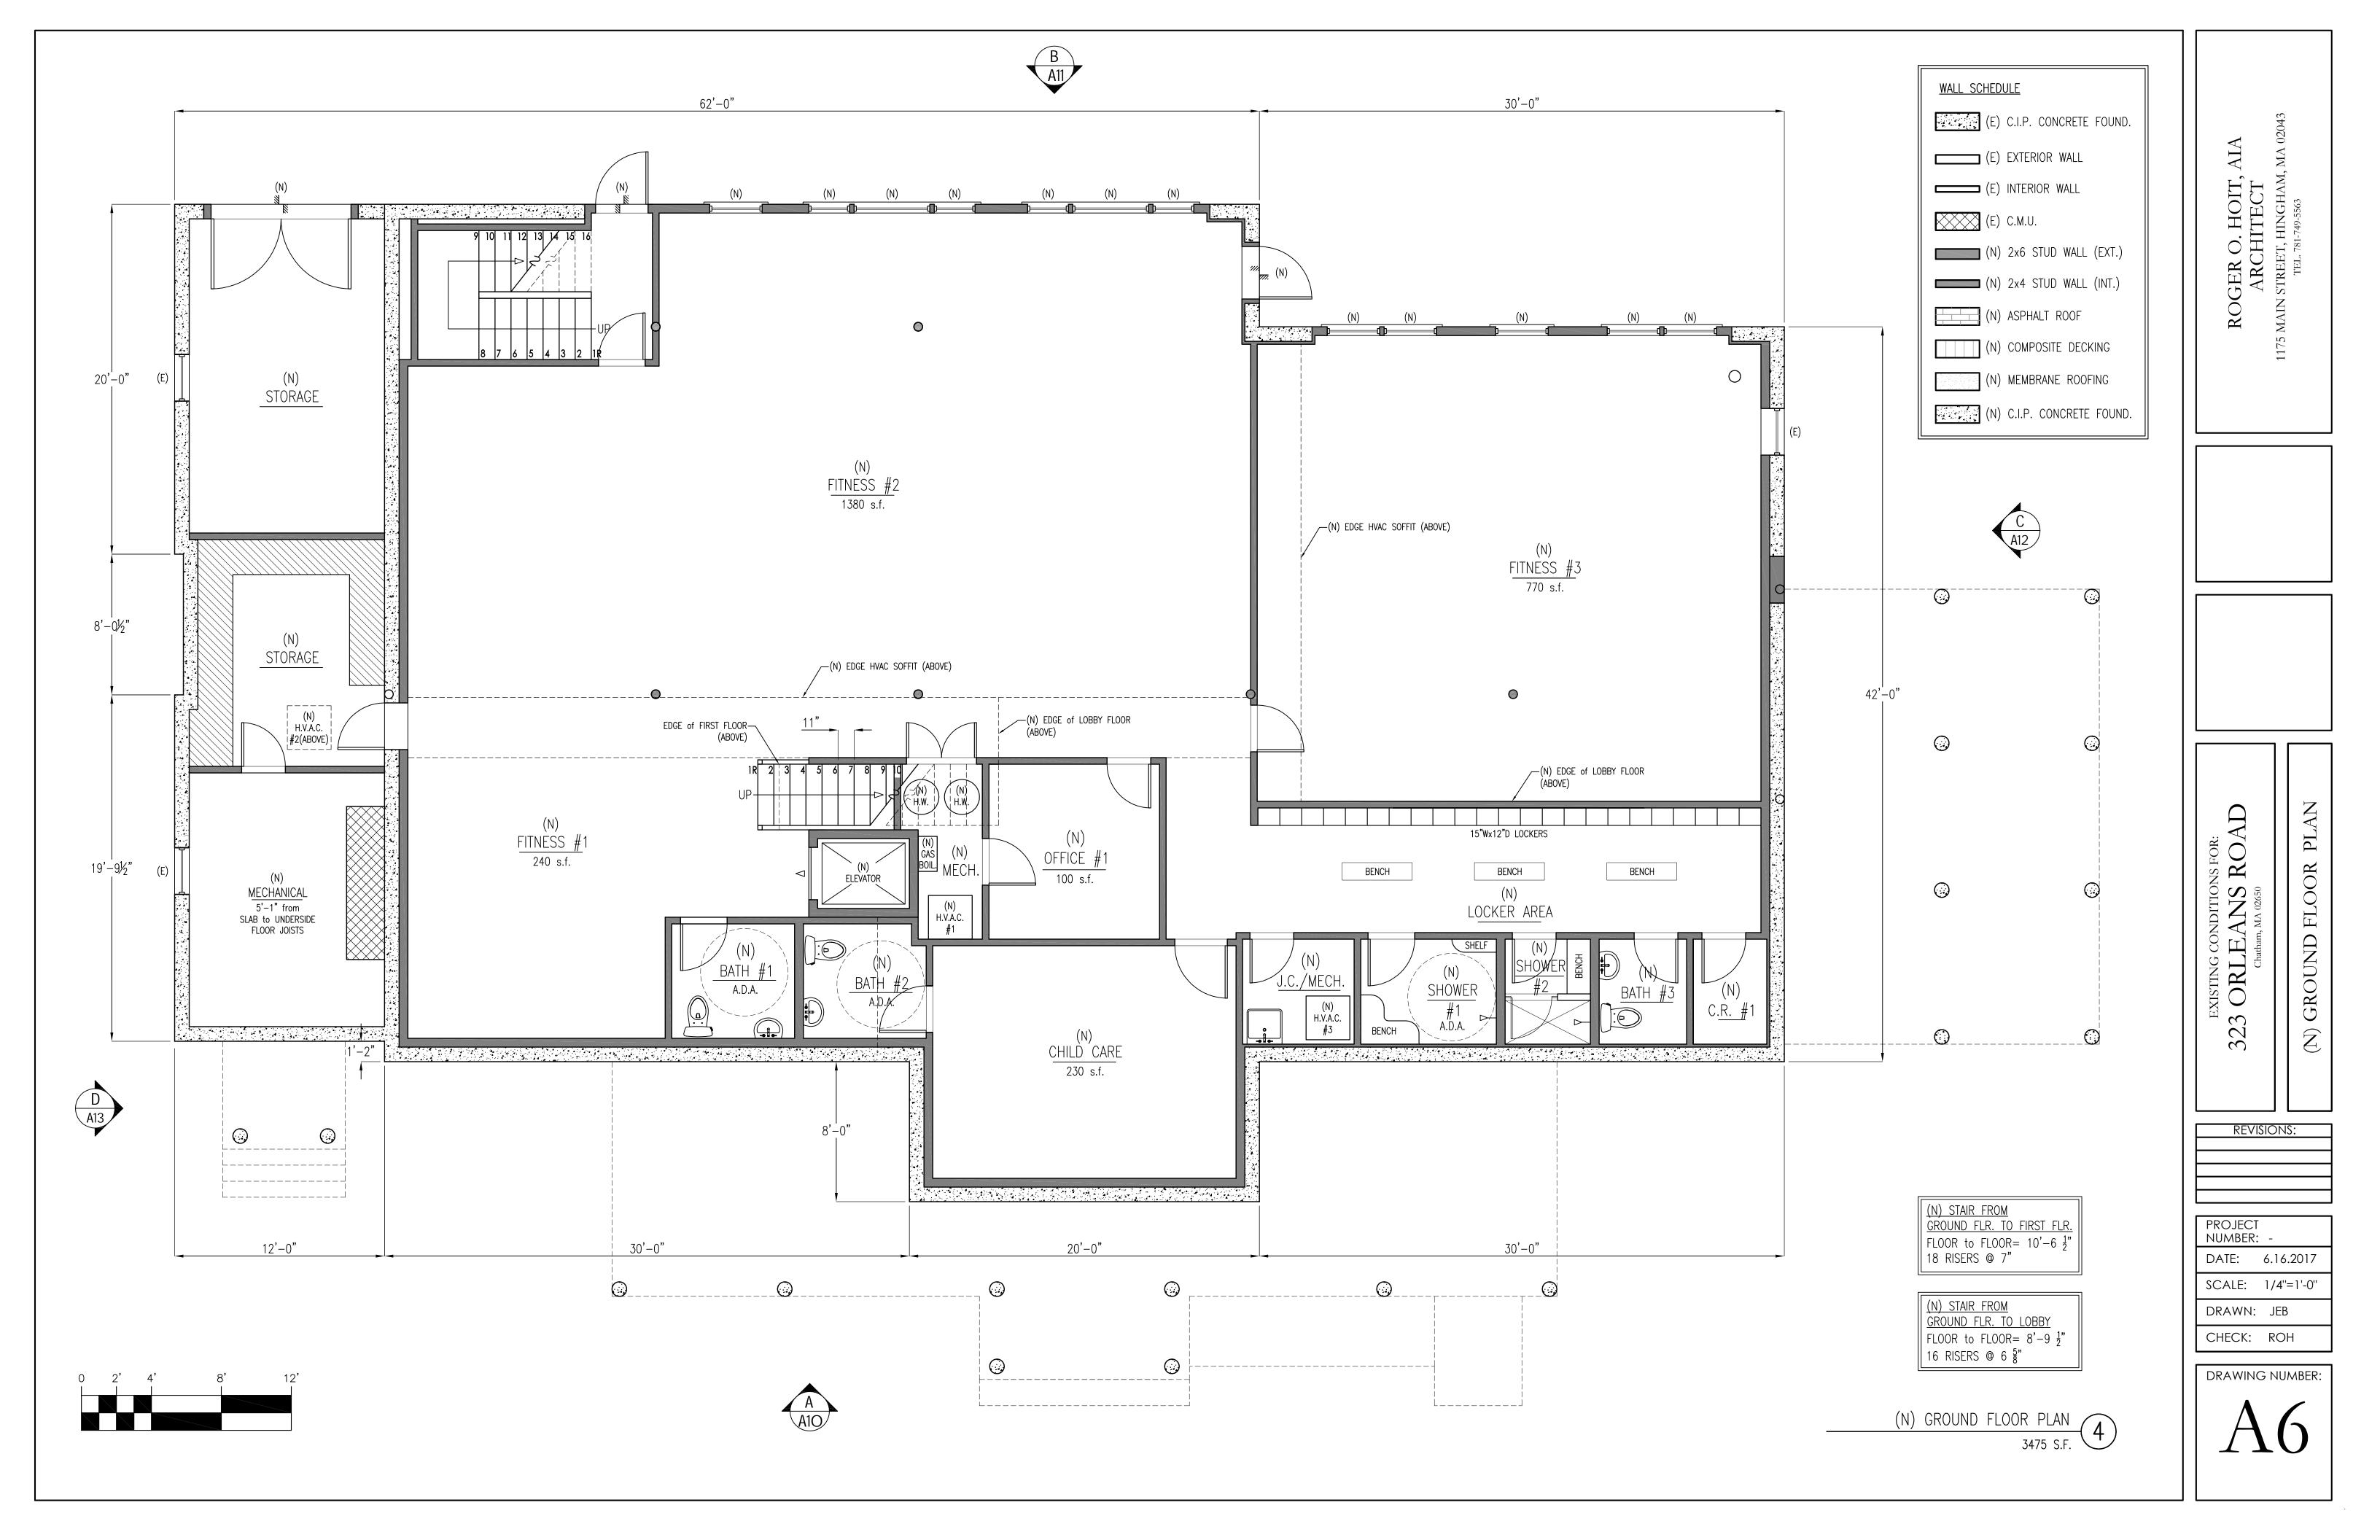


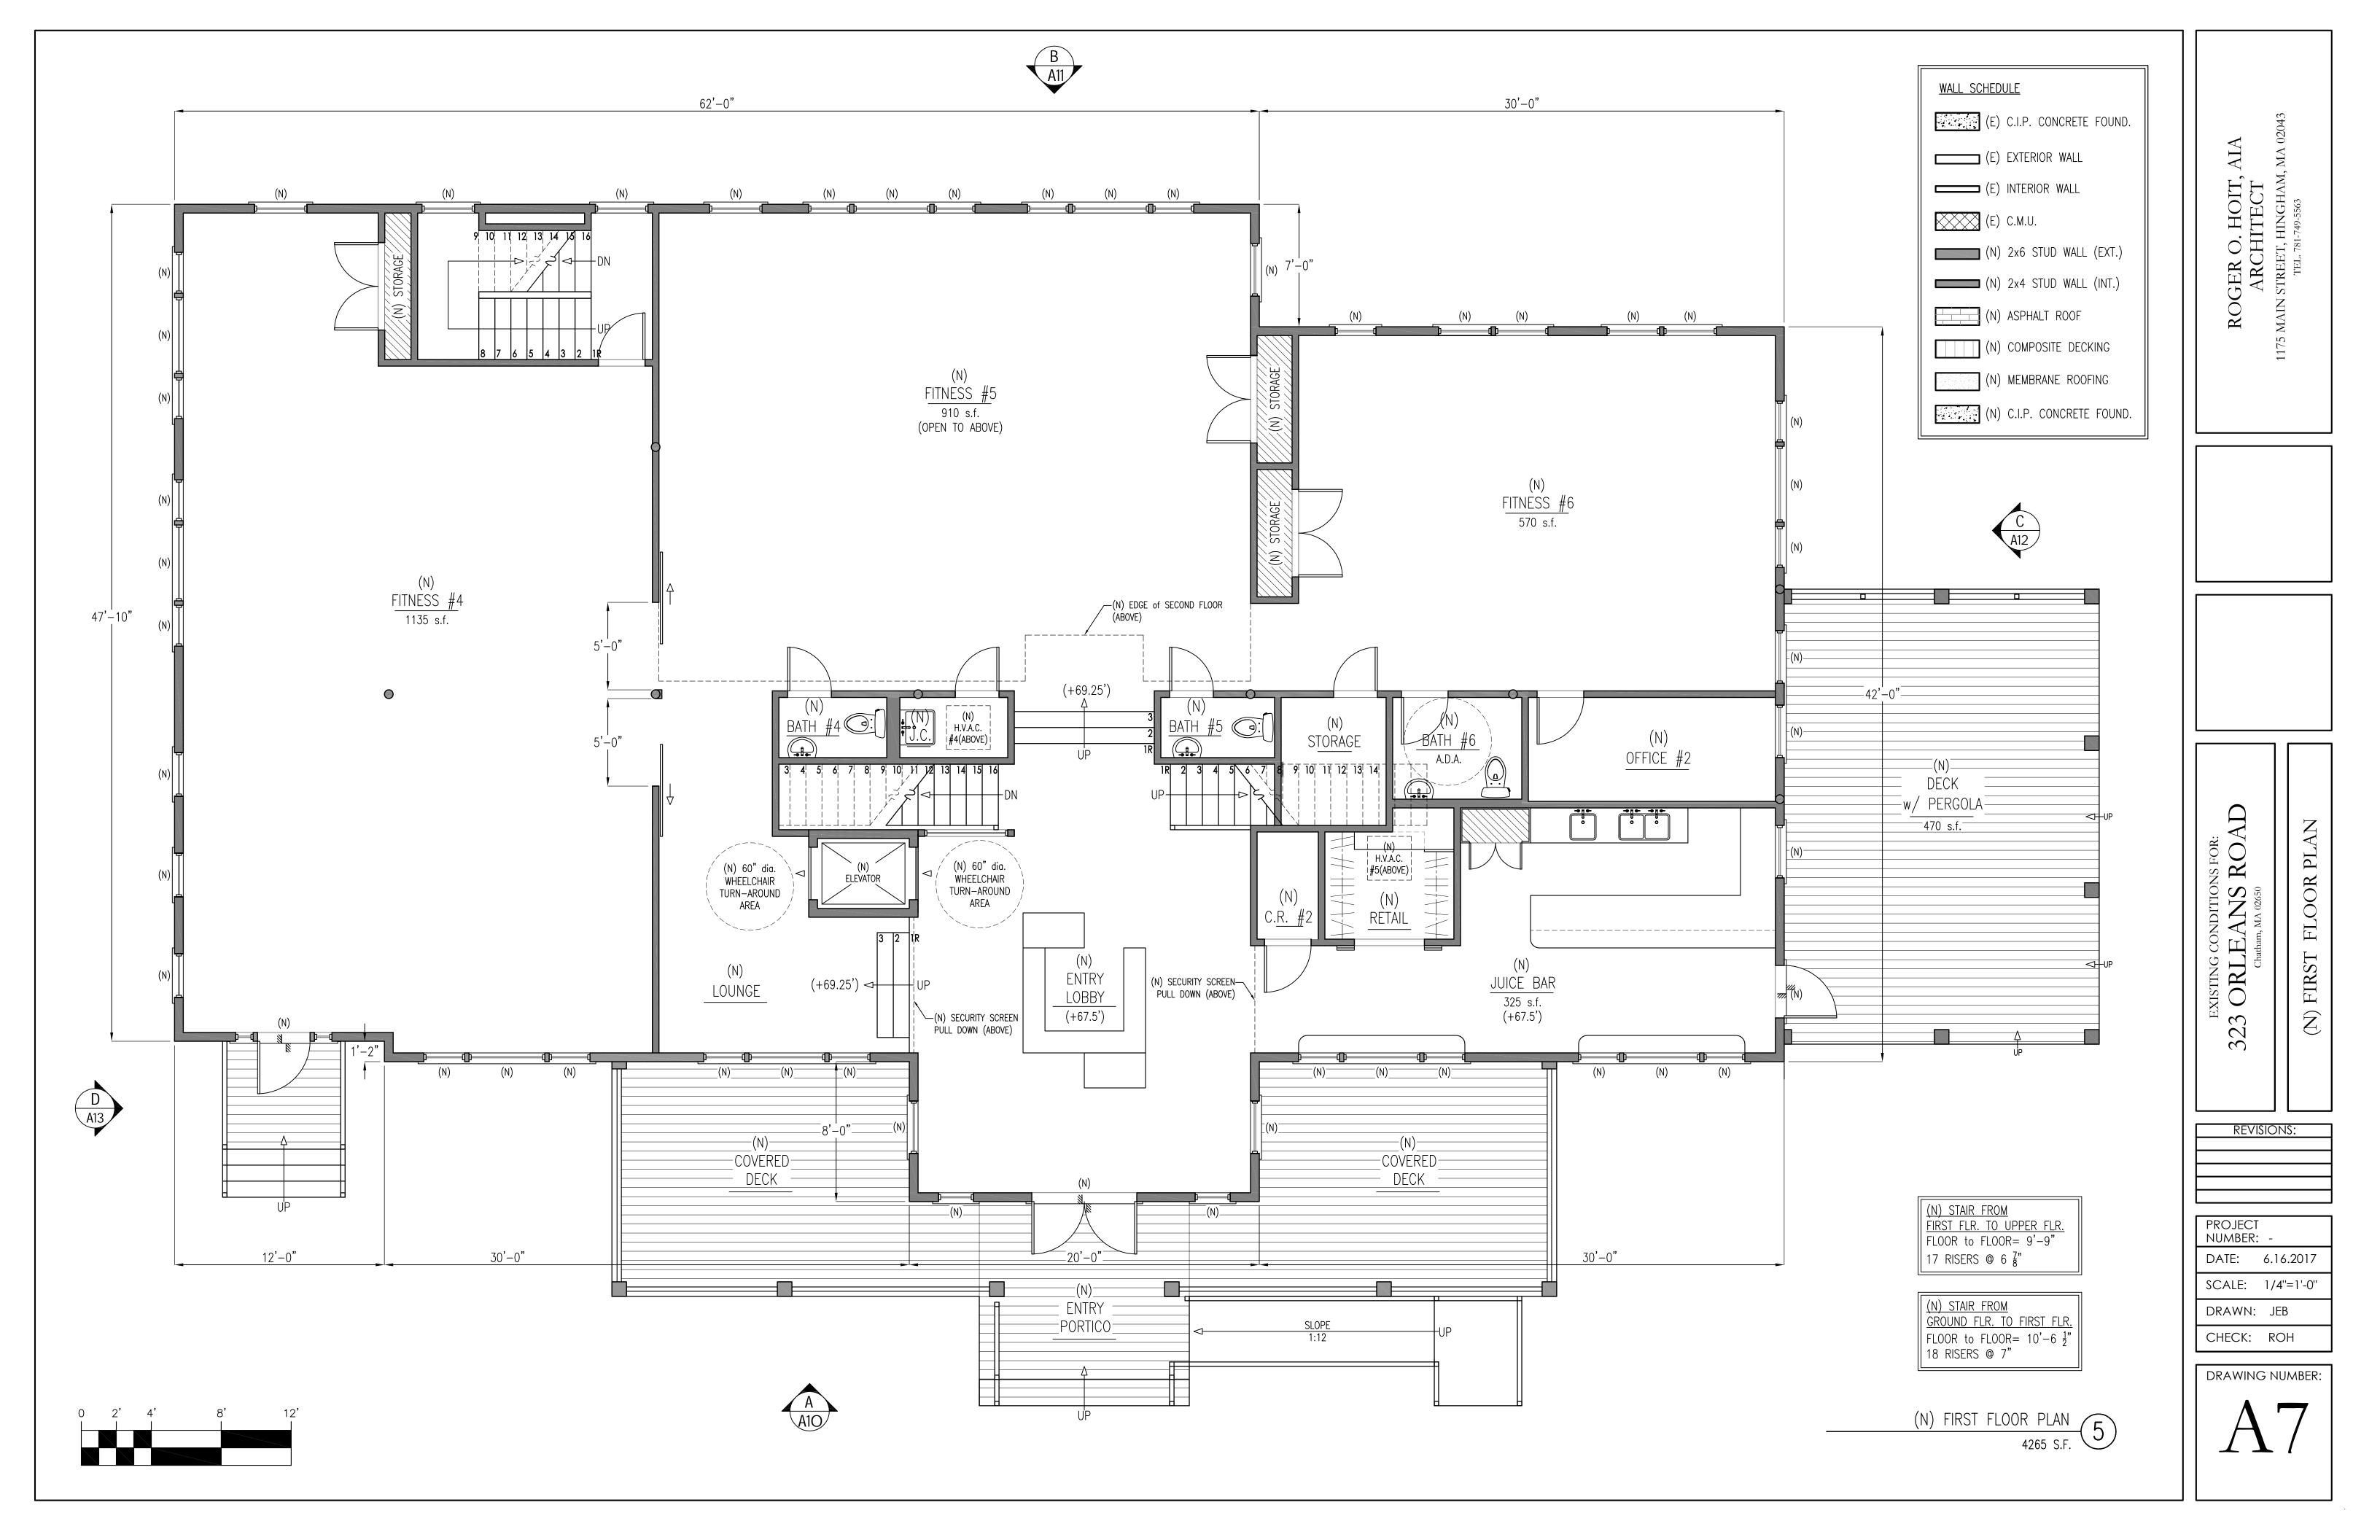REVISIONS:

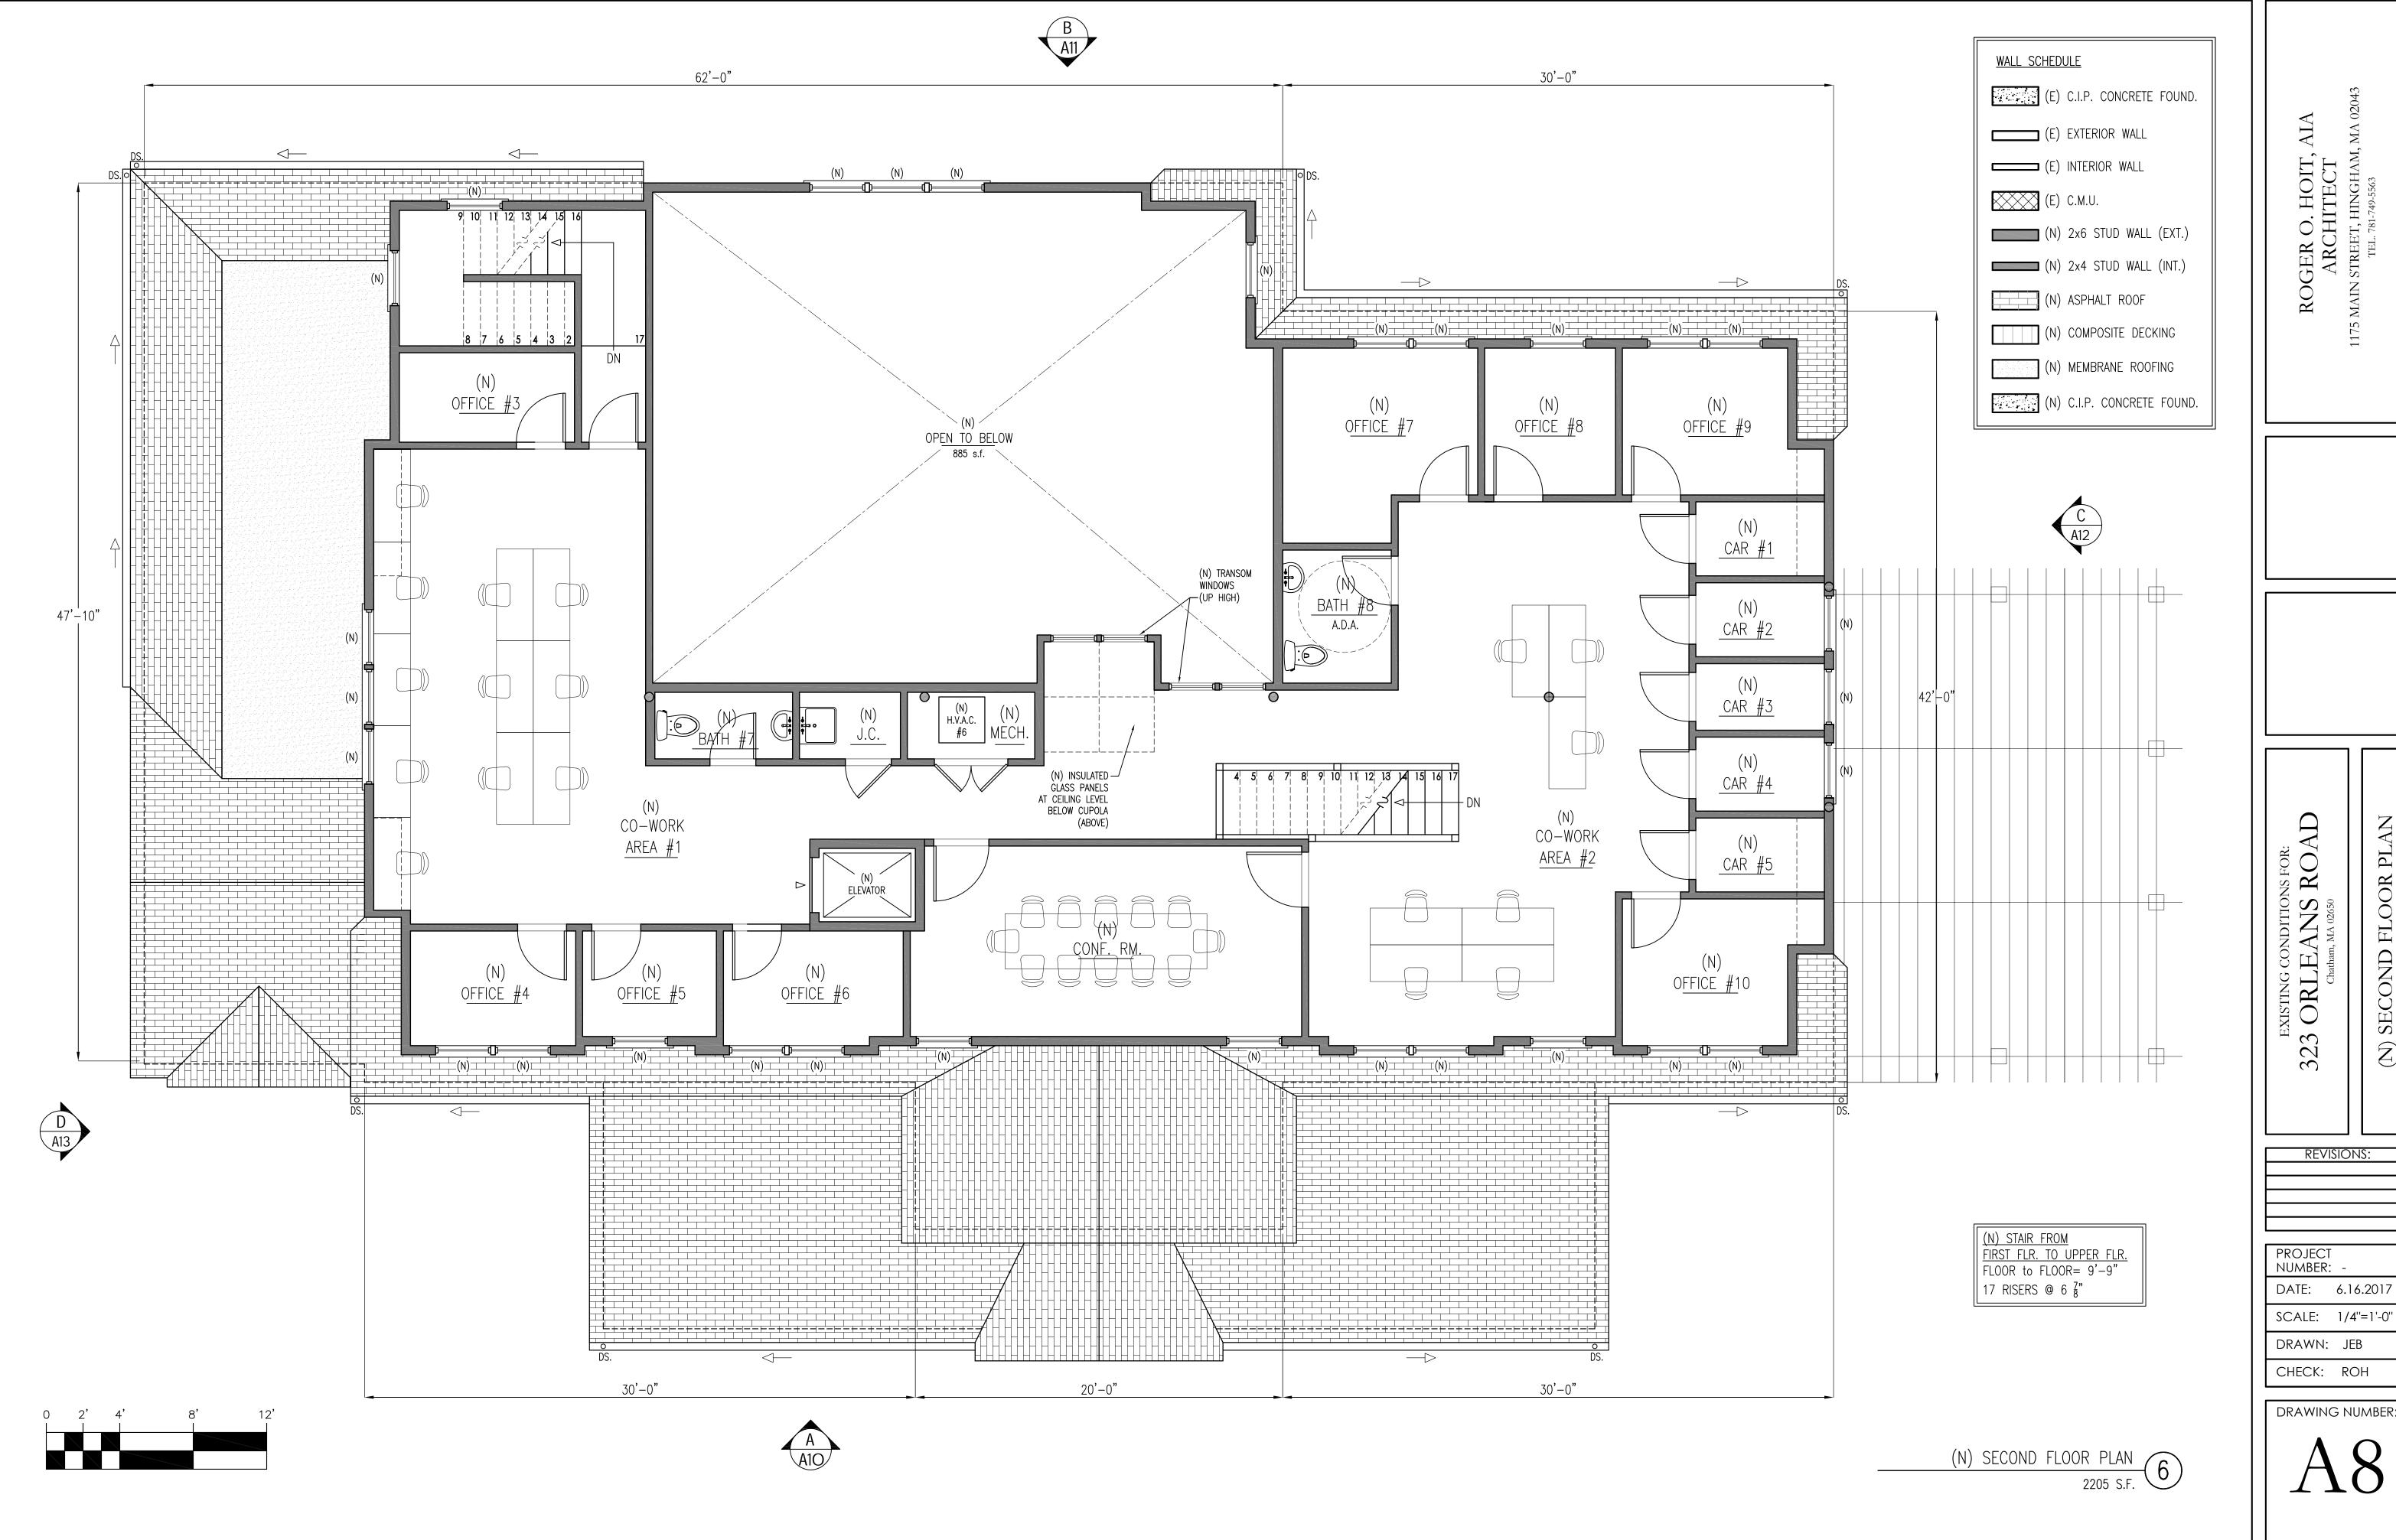SECOND FLOOR PLAN

SCALE: 1/4"=1'-0"

DRAWN: JEB

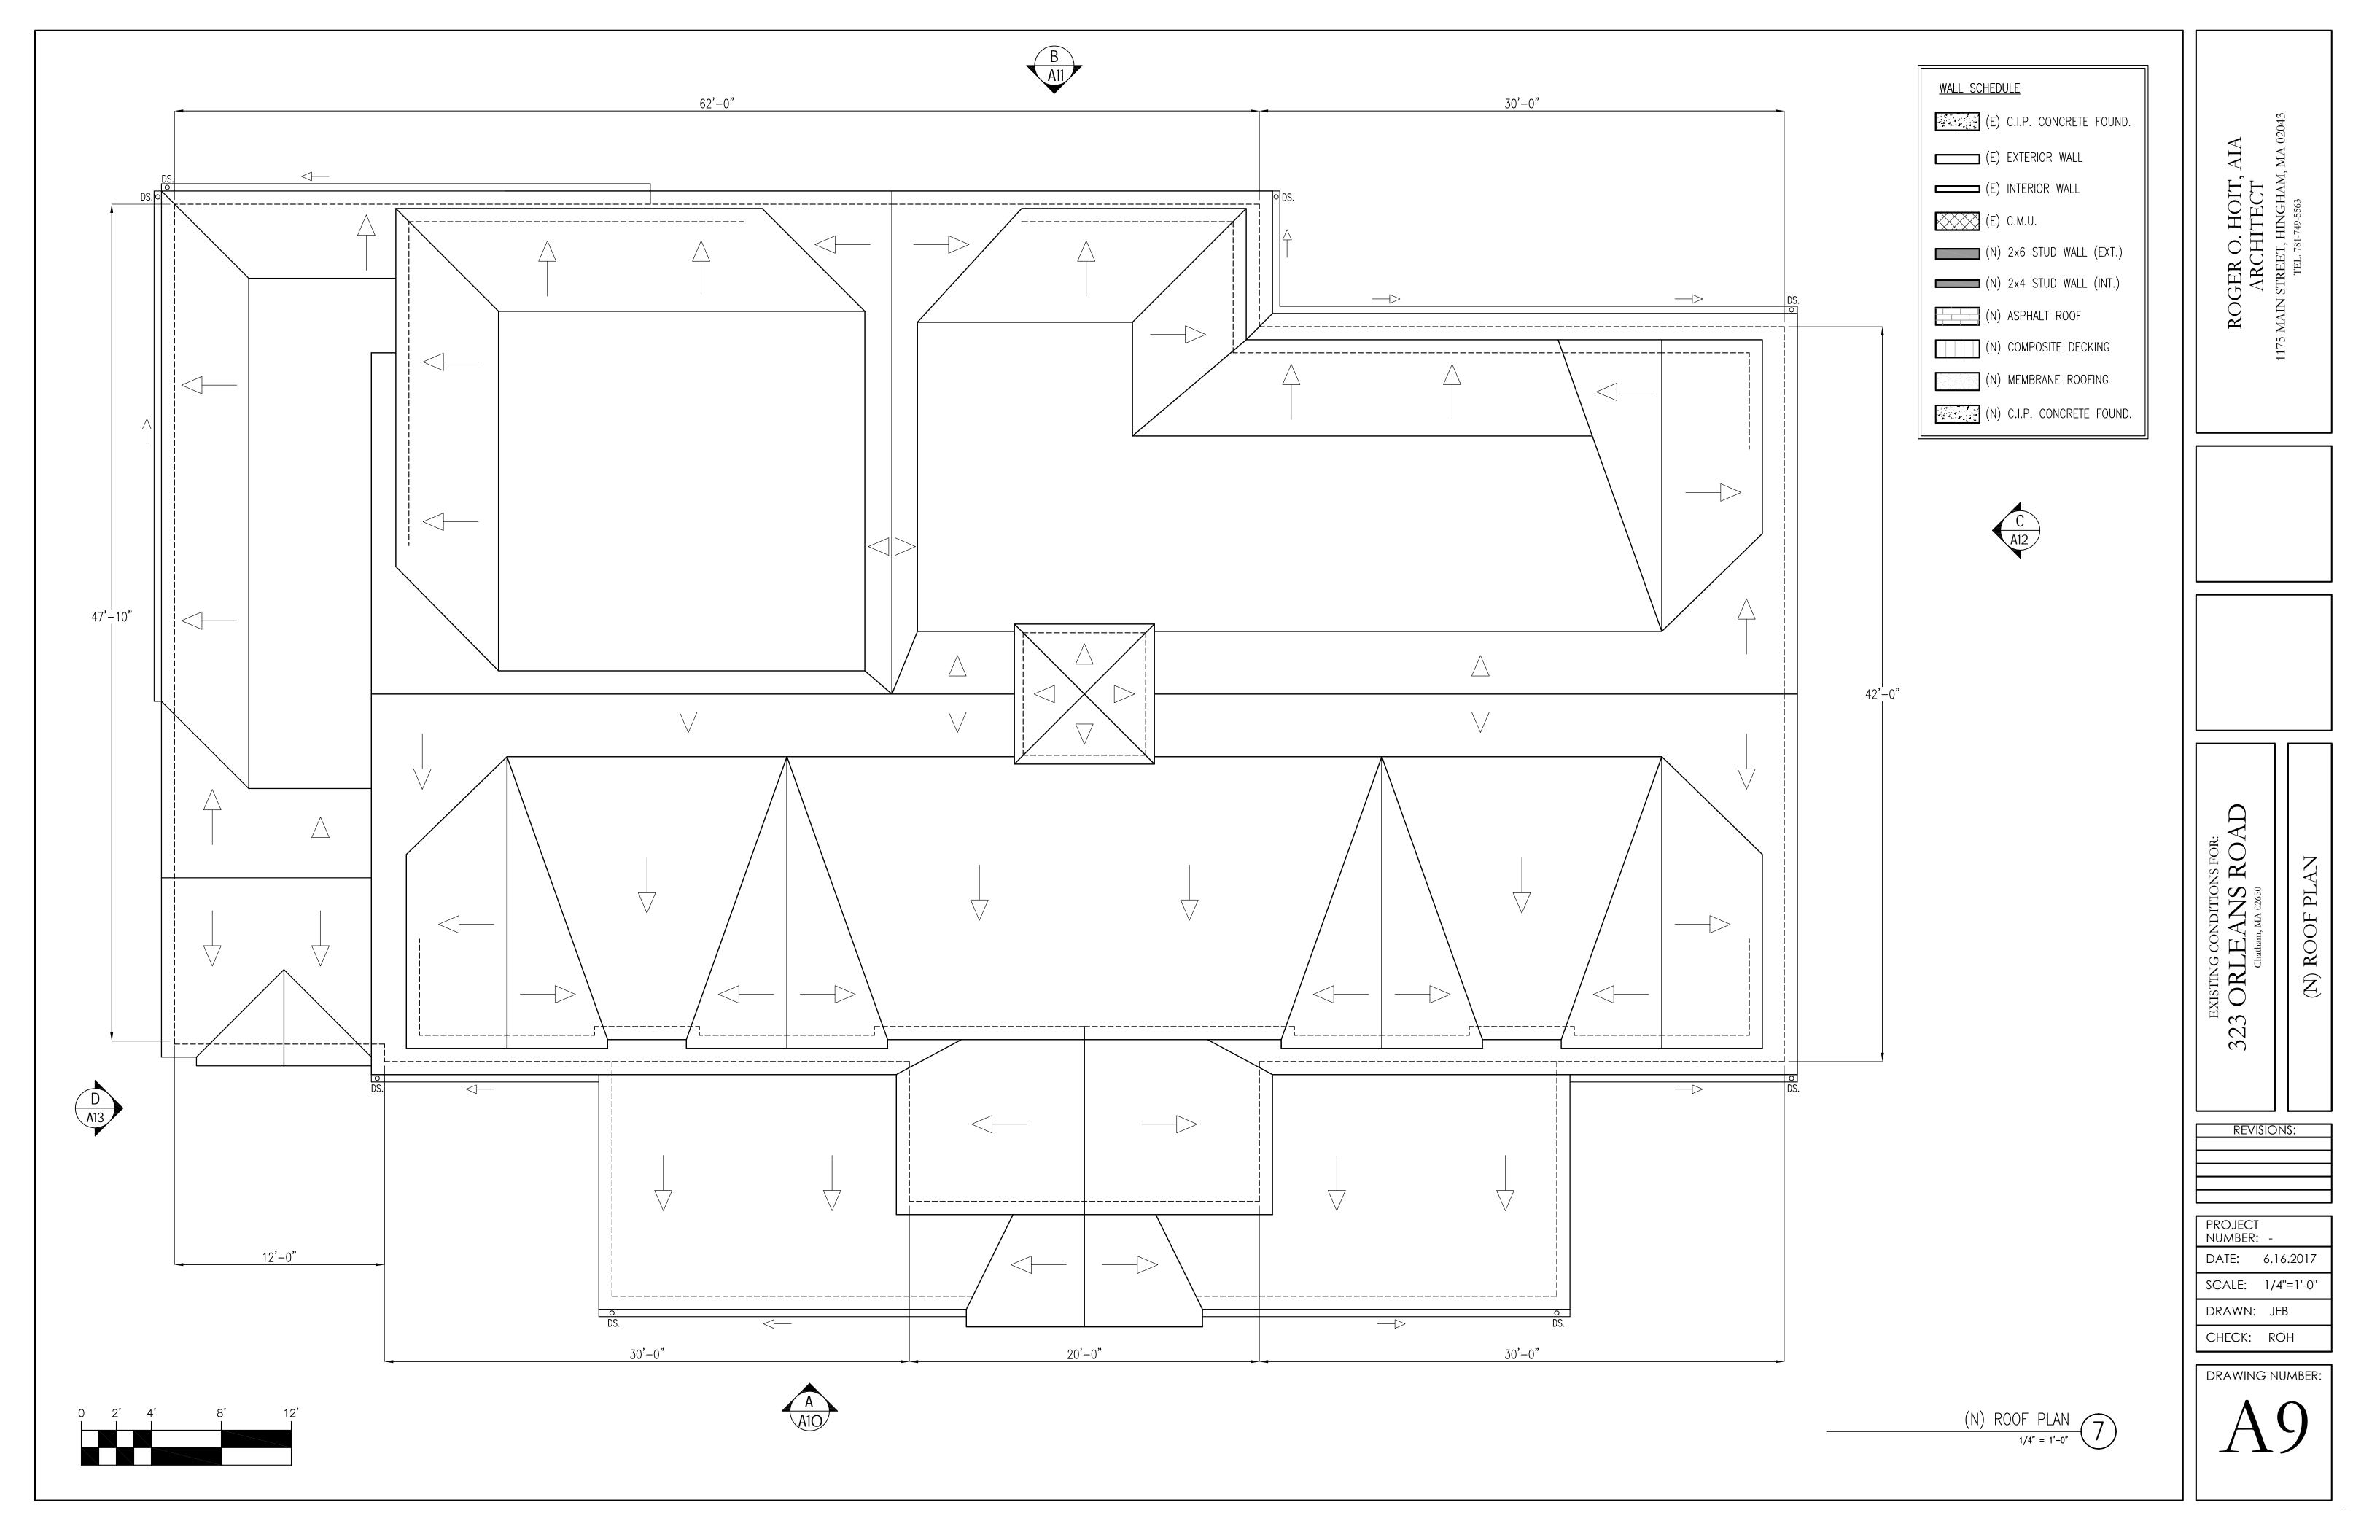



G CONDITIONS FOR:
LEANS ROAD
Chatham, MA 02650

ATION

(N) FRONT ELEV

EXISTING CONDITIONS 323 ORLEANS R

REVISIONS:


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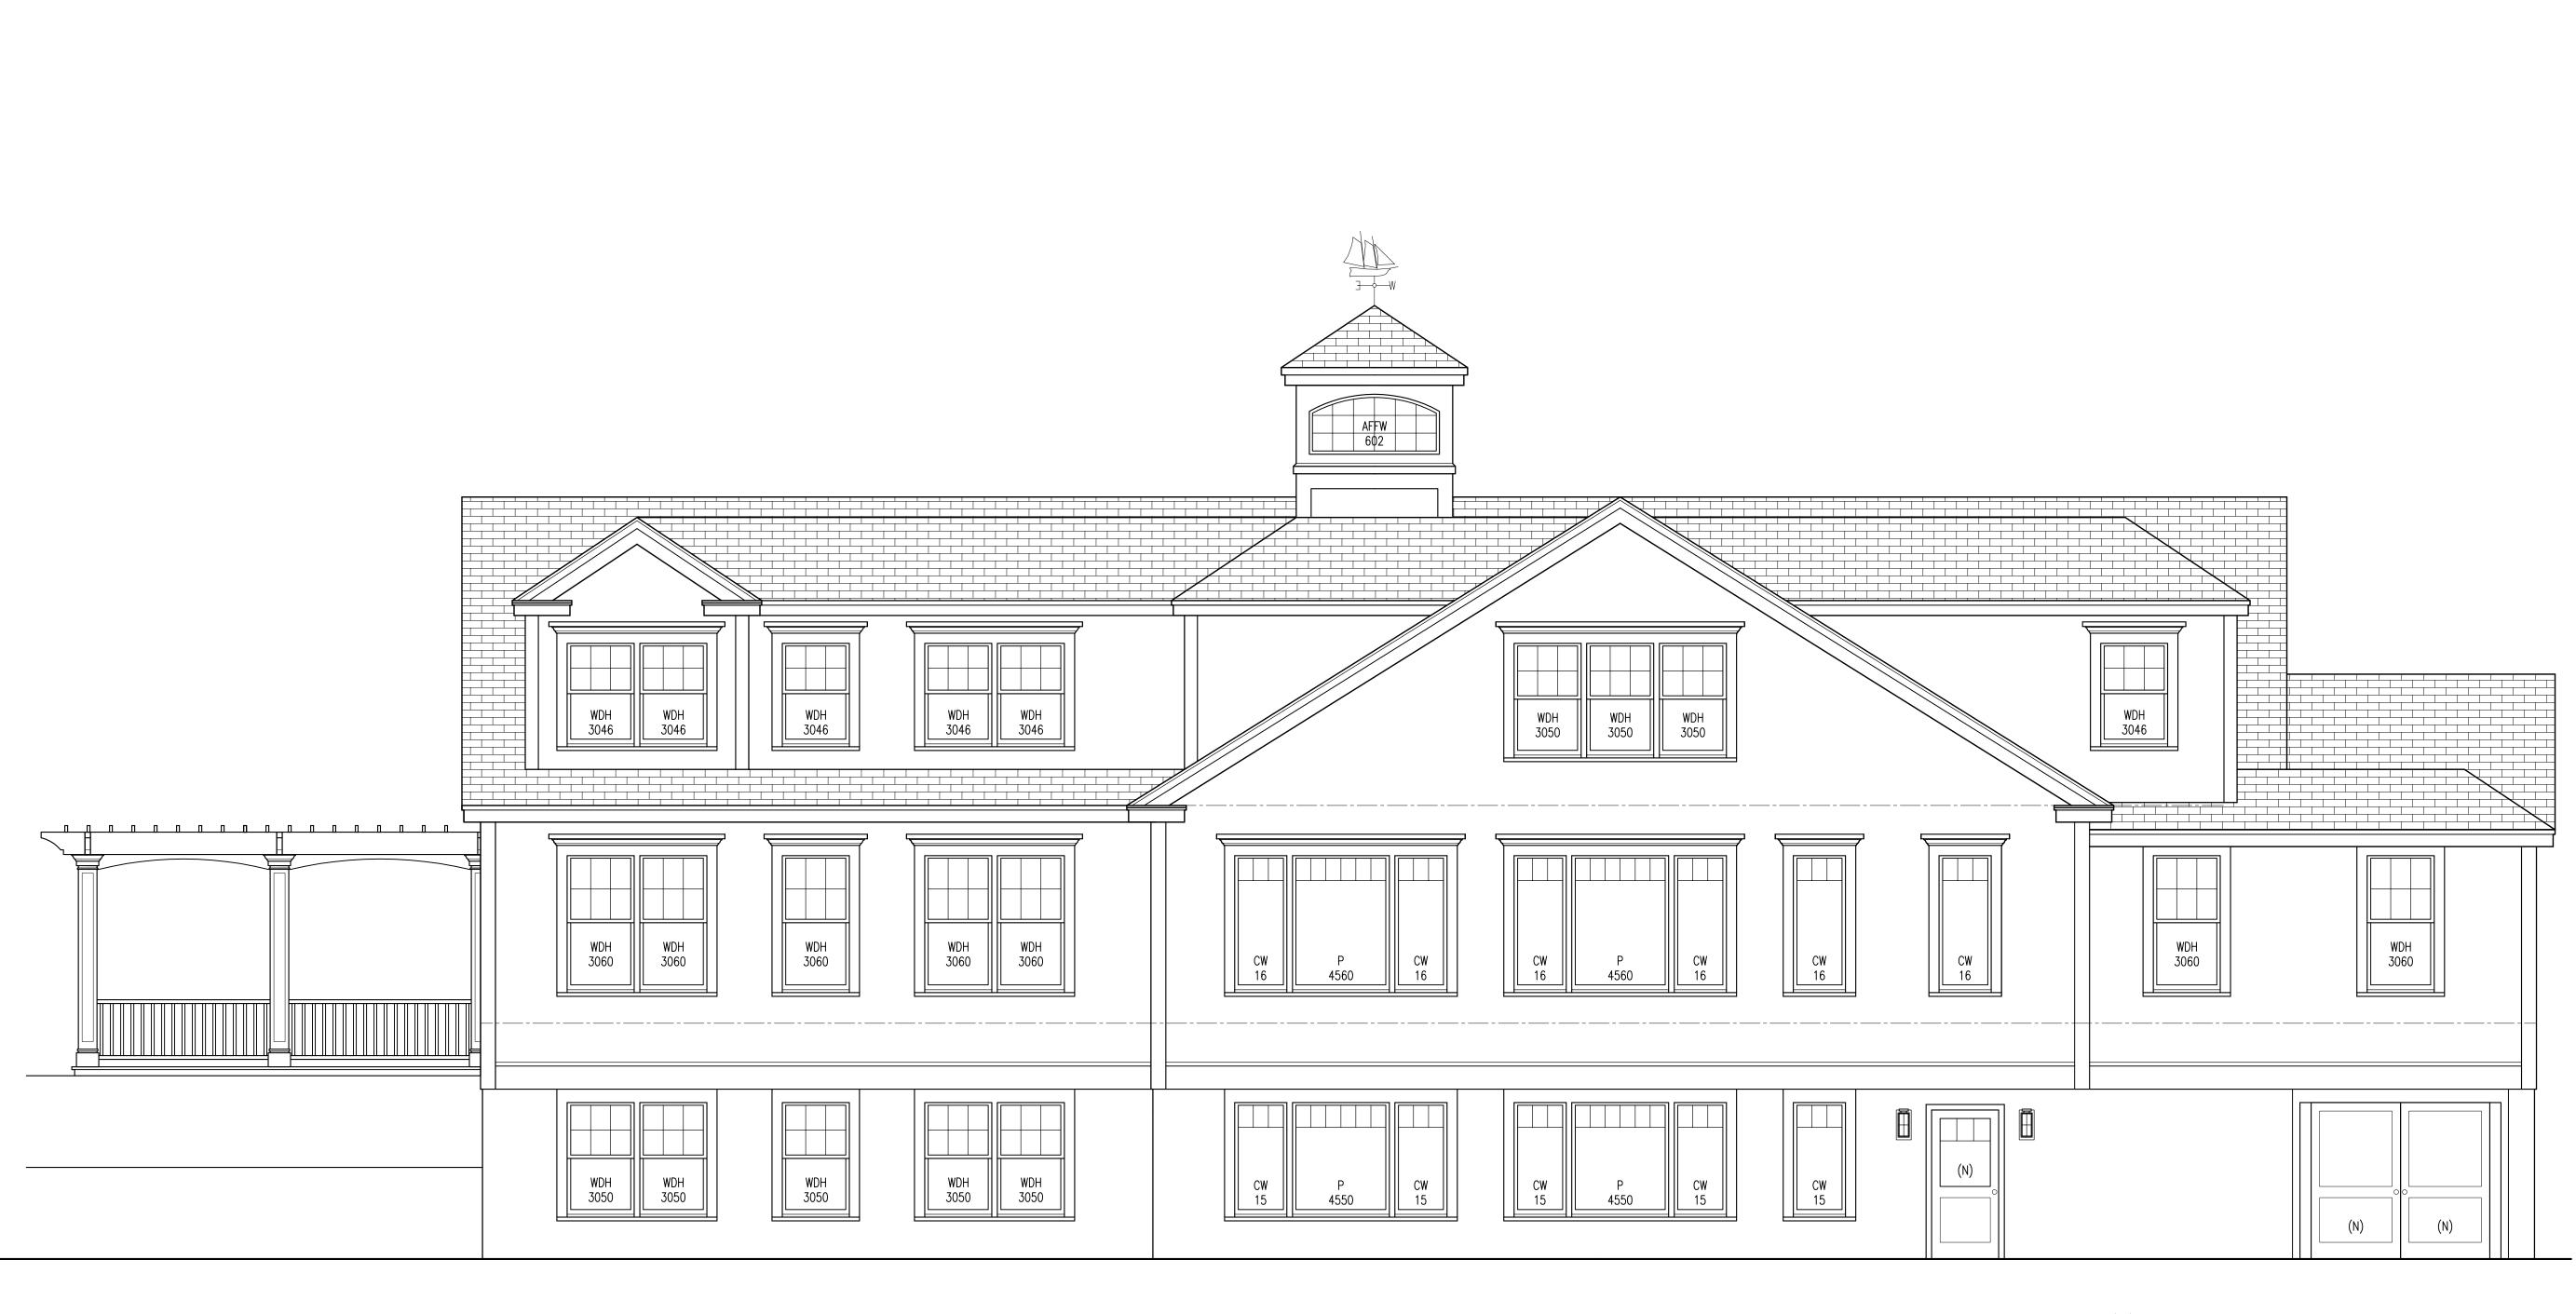
NUMBER: -DATE: 6.16.2017

SCALE: 1/4"=1'-0"

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CHECK: ROH

DRAWING NUMBER:



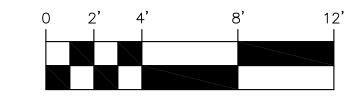

(N) REAR ELEVATION B

ROGER O. HOIT, AIA
ARCHITECT
1175 MAIN STREET, HINGHAM, MA 02043
TEL. 781-749-5563

EXISTING CONDITIONS FOR:

323 ORLEANS ROAD

Chatham, MA 02650

(N) REAR ELEVA

REVISIONS:

PROJECT NUMBER: -DATE: 6.16.2017


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CHECK: ROH

DRAWING NUMBER:

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EXISTING CONDITIONS FOR:

323 ORLEANS ROAD

Chatham, MA 02650

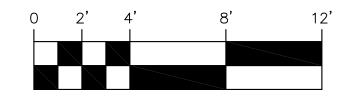(N) SIDE ELEVATION

REVISIONS:

PROJECT NUMBER: -


DATE: 6.16.2017

SCALE: 1/4"=1'-0"

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CHECK: ROH

DRAWING NUMBER:



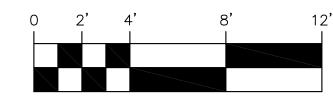

EXISTING CONDITIONS FOR:

323 ORLEANS ROAD

Chatham, MA 02650

(N) SIDE ELEVATION

REVISIONS:

PROJECT NUMBER: -


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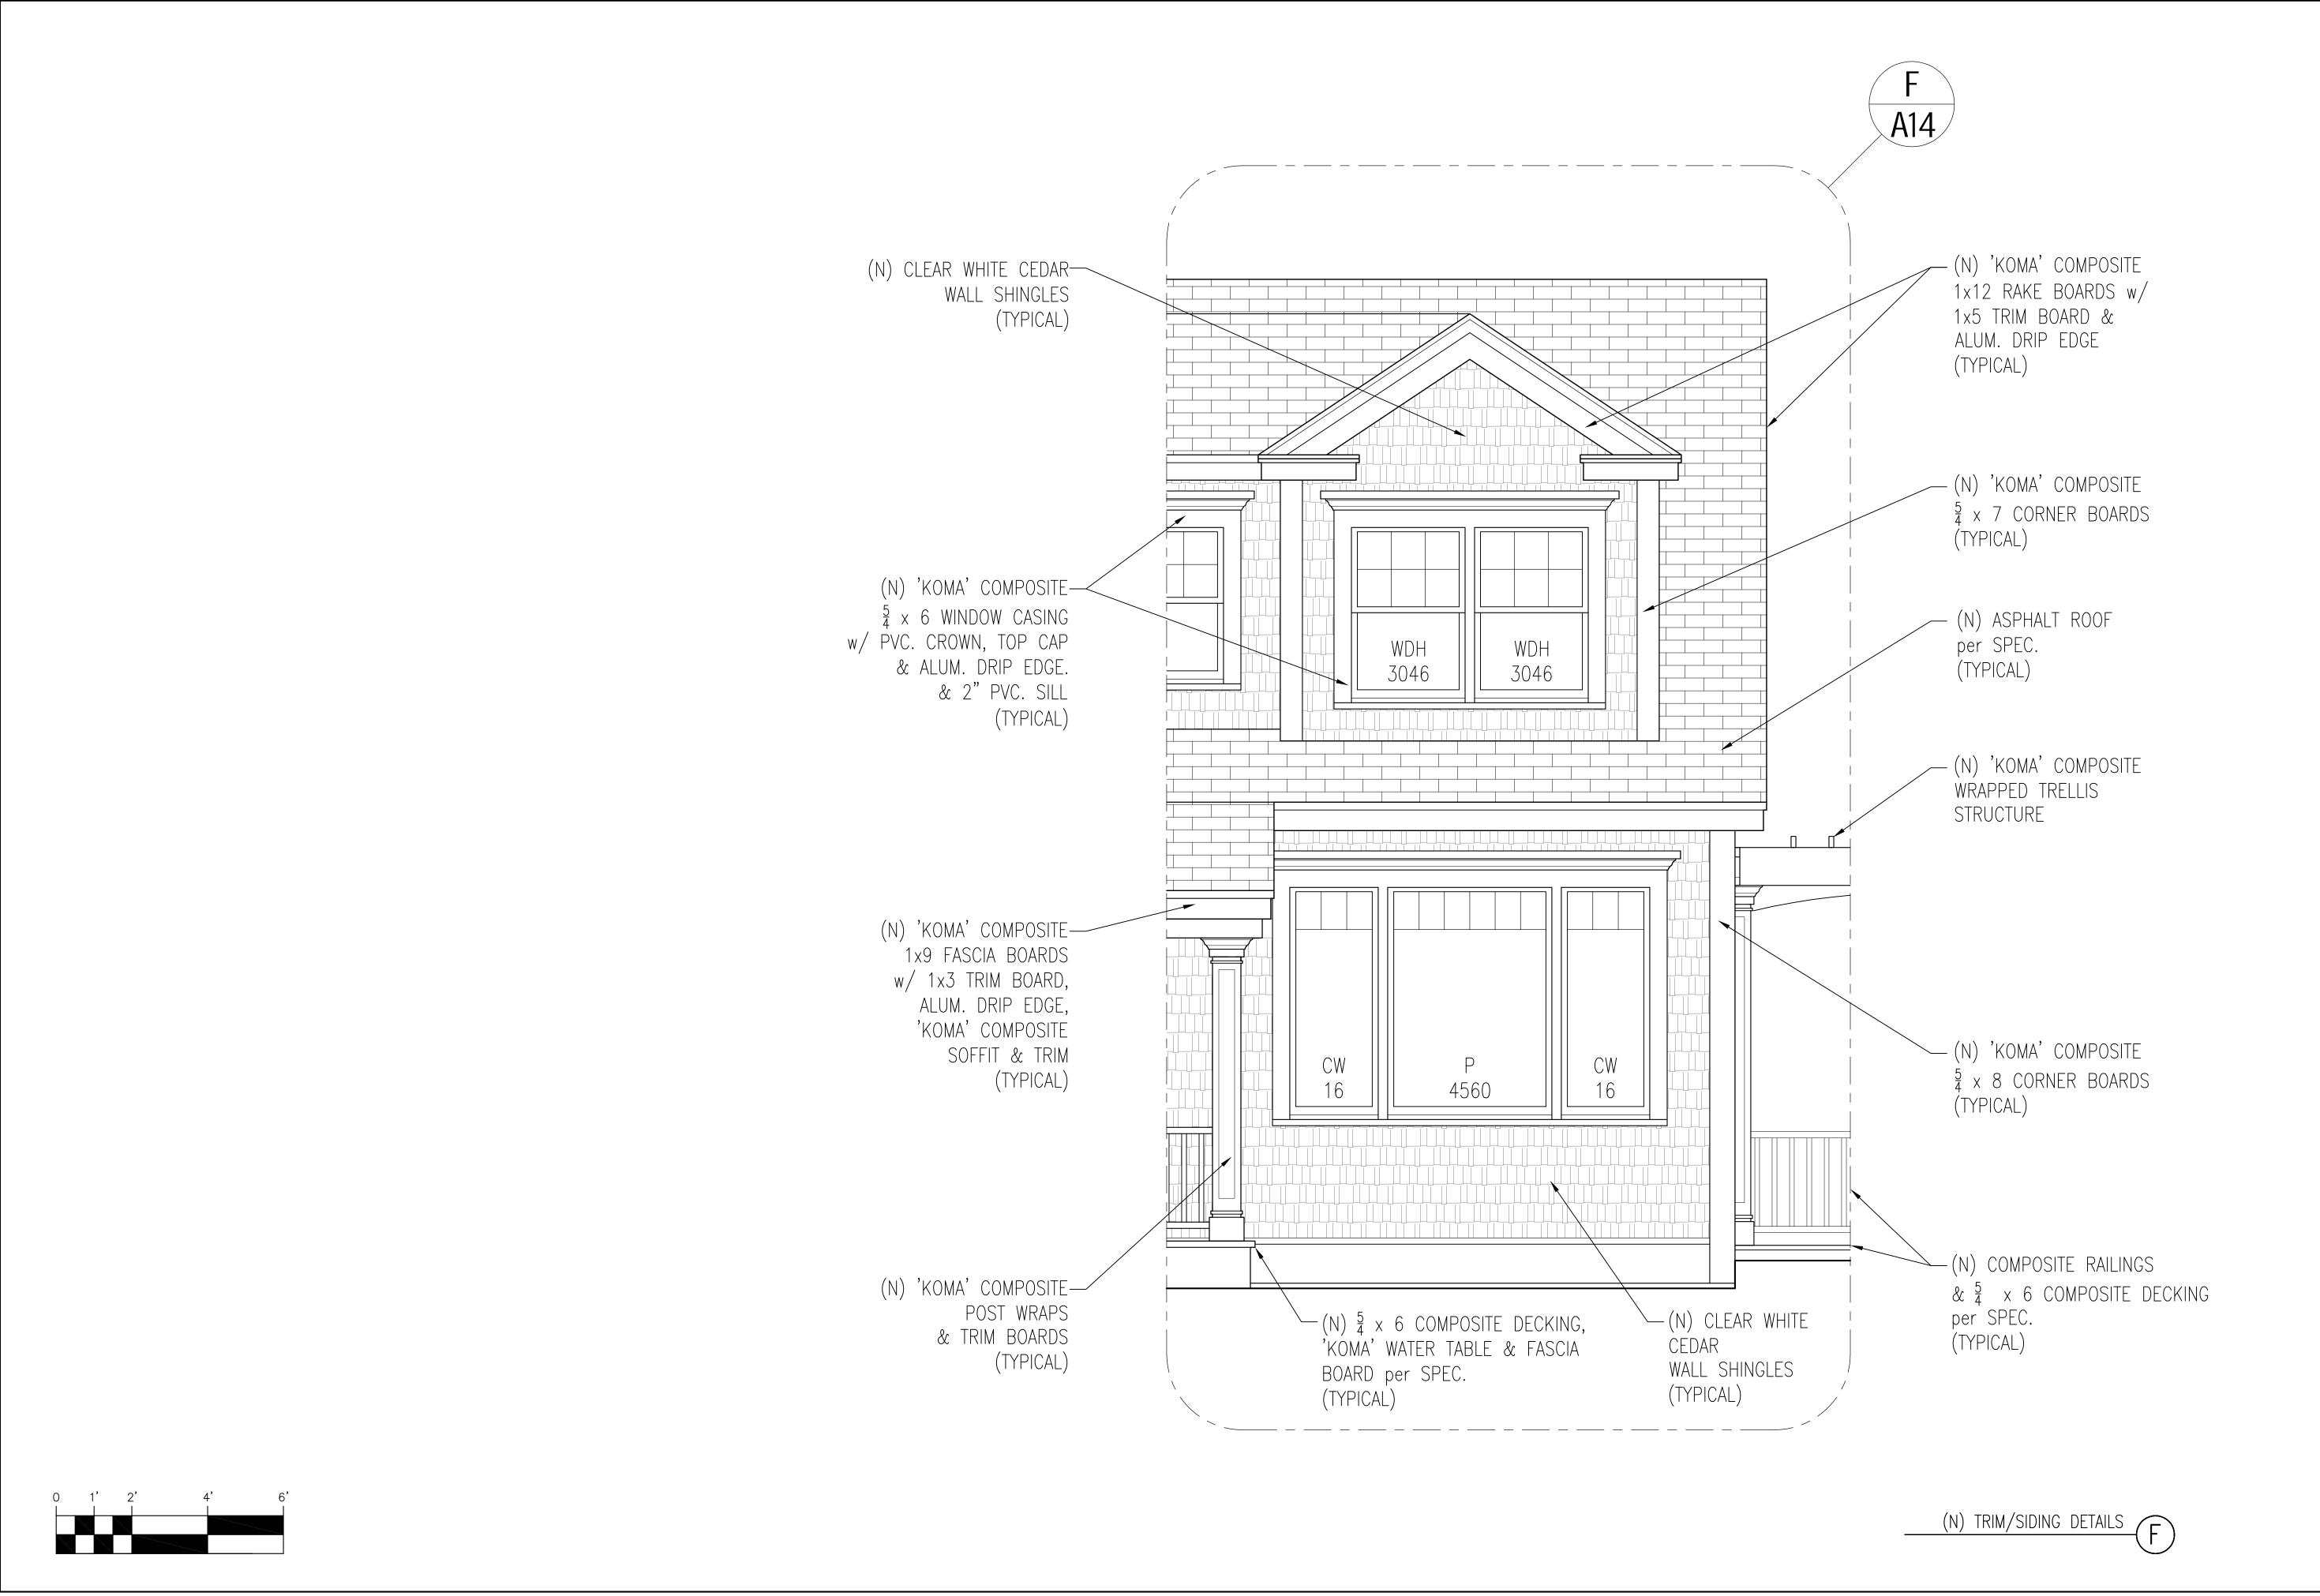
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DRAWING NUMBER:





ONDITIONS FOR:
ANS ROAD

um, MA 02650

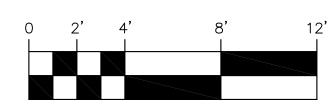EXISTING CONDITIONS
323 ORLEANS I
Chatham, MA 02650

REVISIONS:

PROJECT NUMBER: -DATE: 6.16.2017


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EXISTING CONDITIONS FOR: 323 ORLEANS ROAD Chatham, MA 02650

REVISIONS:

(N) SCHEMATIC CROSS SECTION

PROJECT NUMBER: -DATE: 6.16.2017


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DRAWING NUMBER:

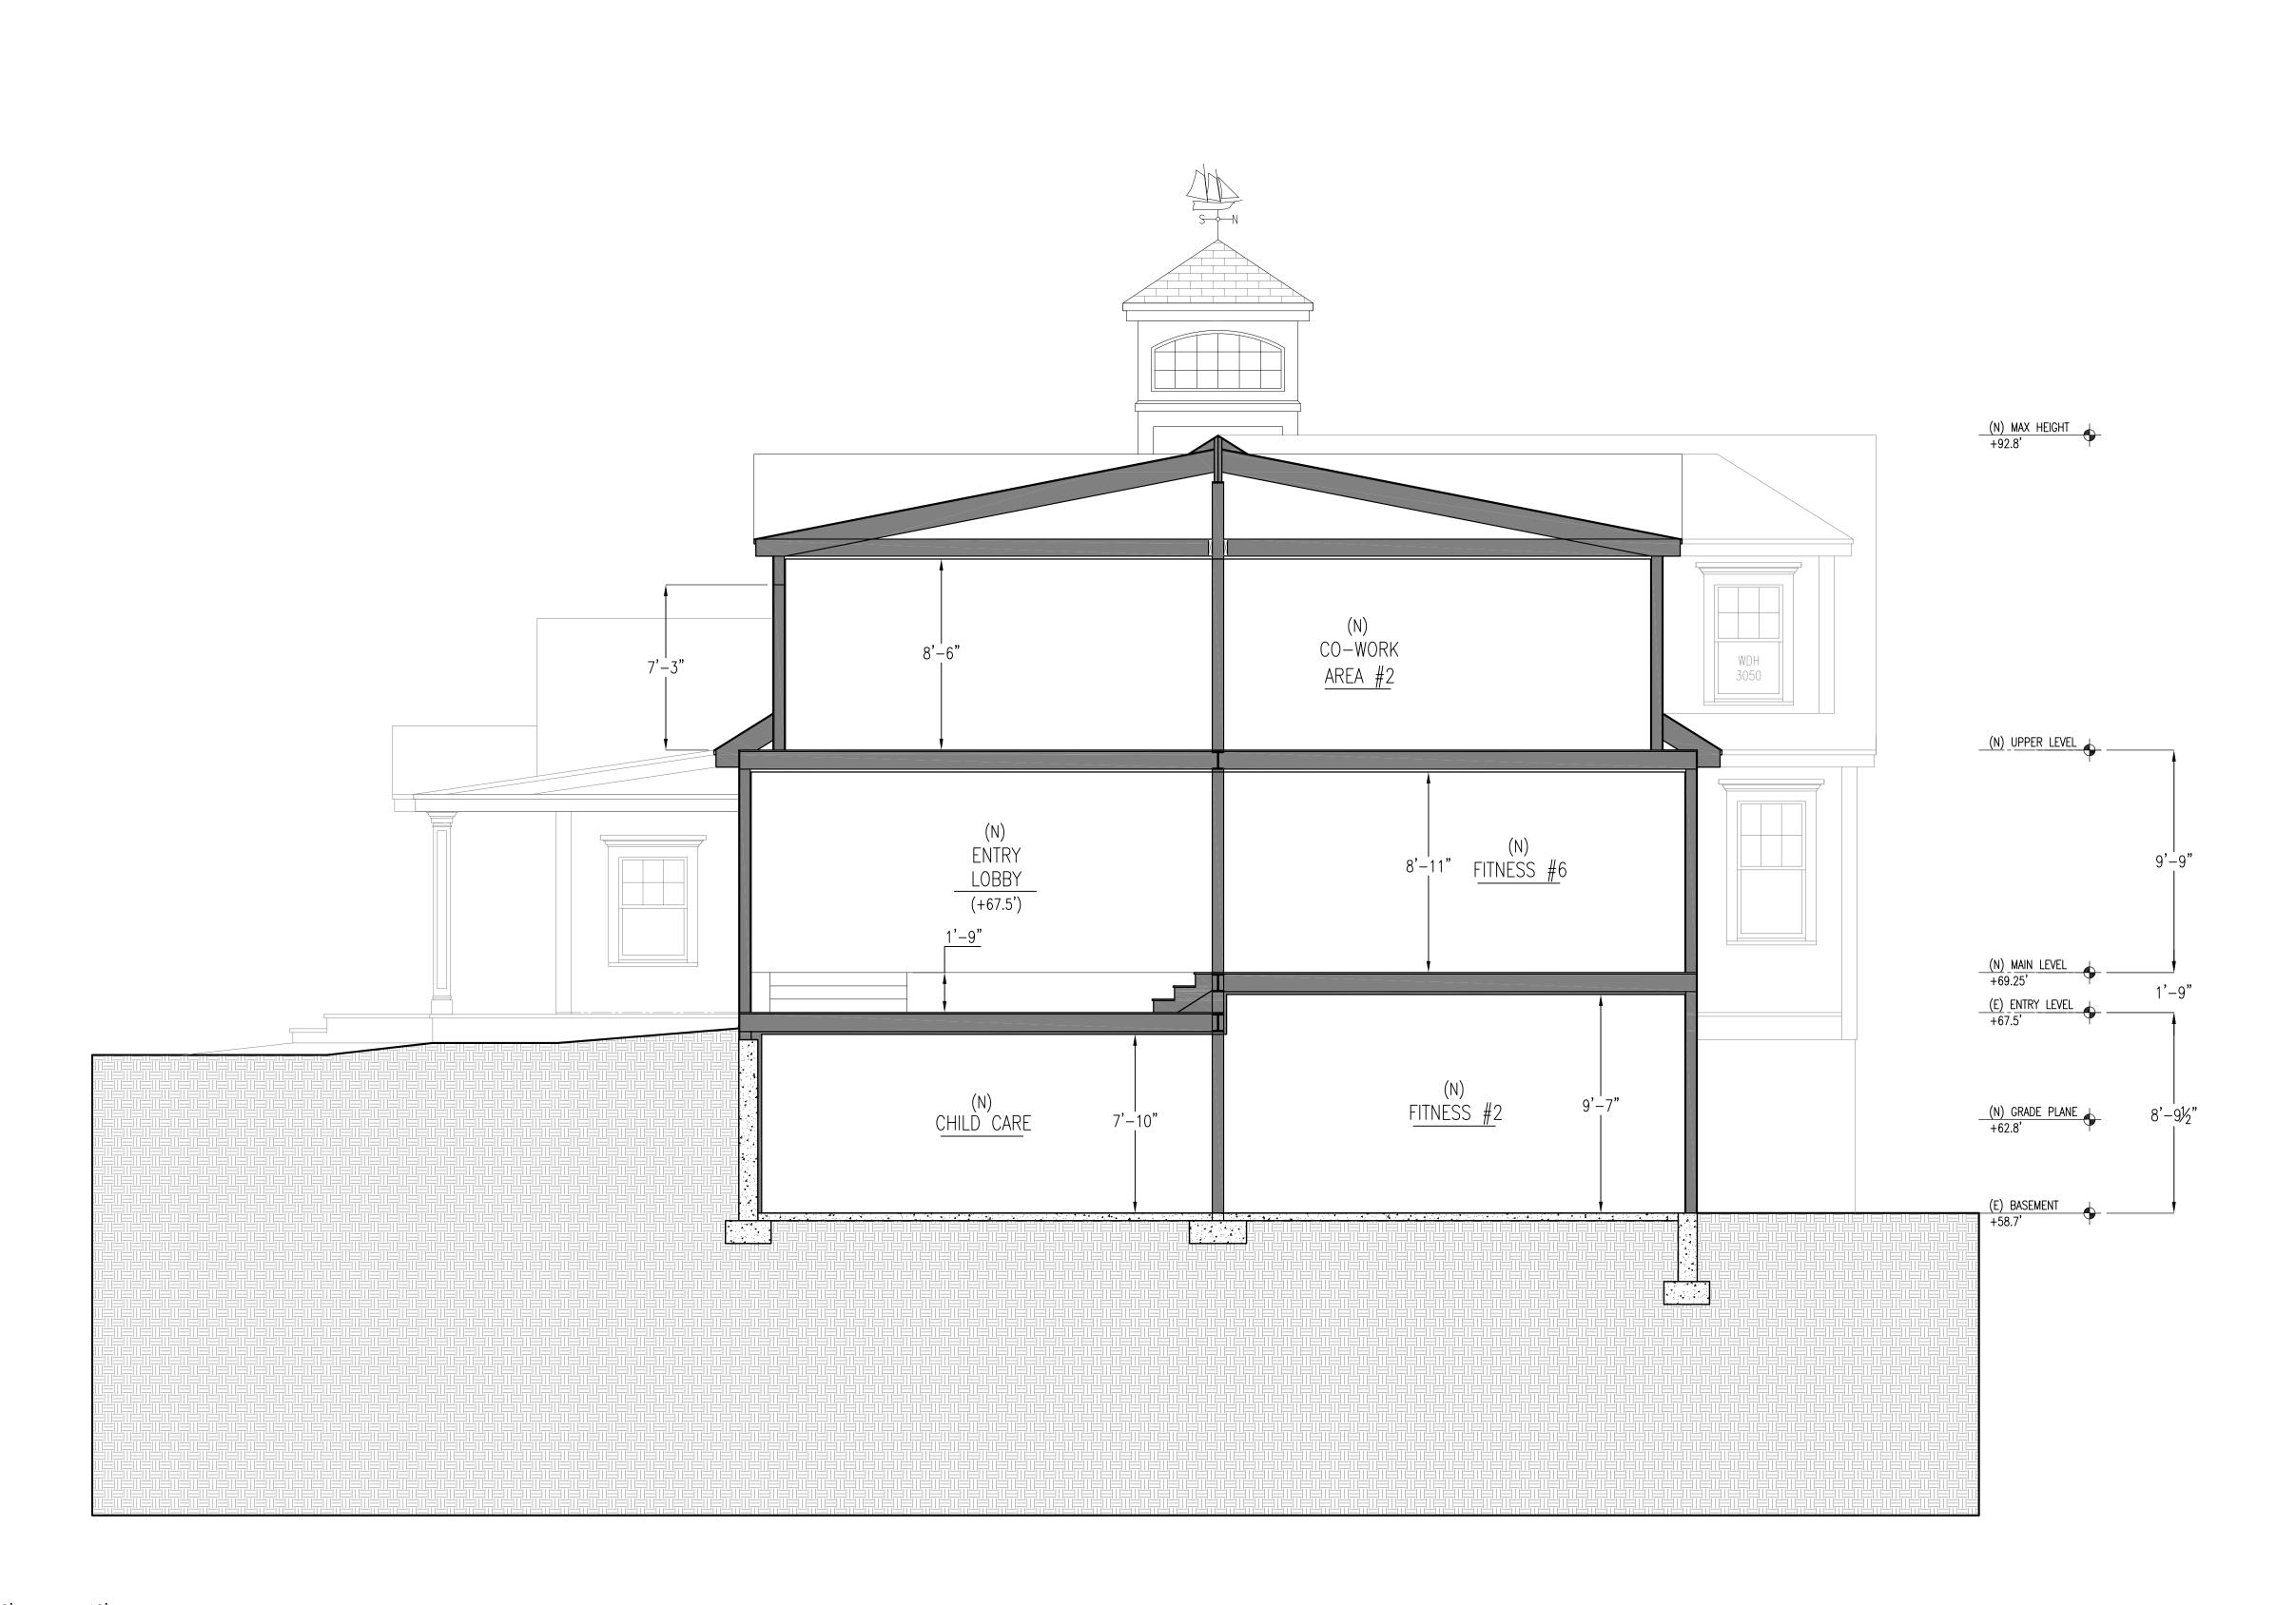(N) SCHEMATIC CROSS SECTION (AA)



ROGER O. HOIT, AIA
ARCHITECT
1175 MAIN STREET, HINGHAM, MA 02043

Z

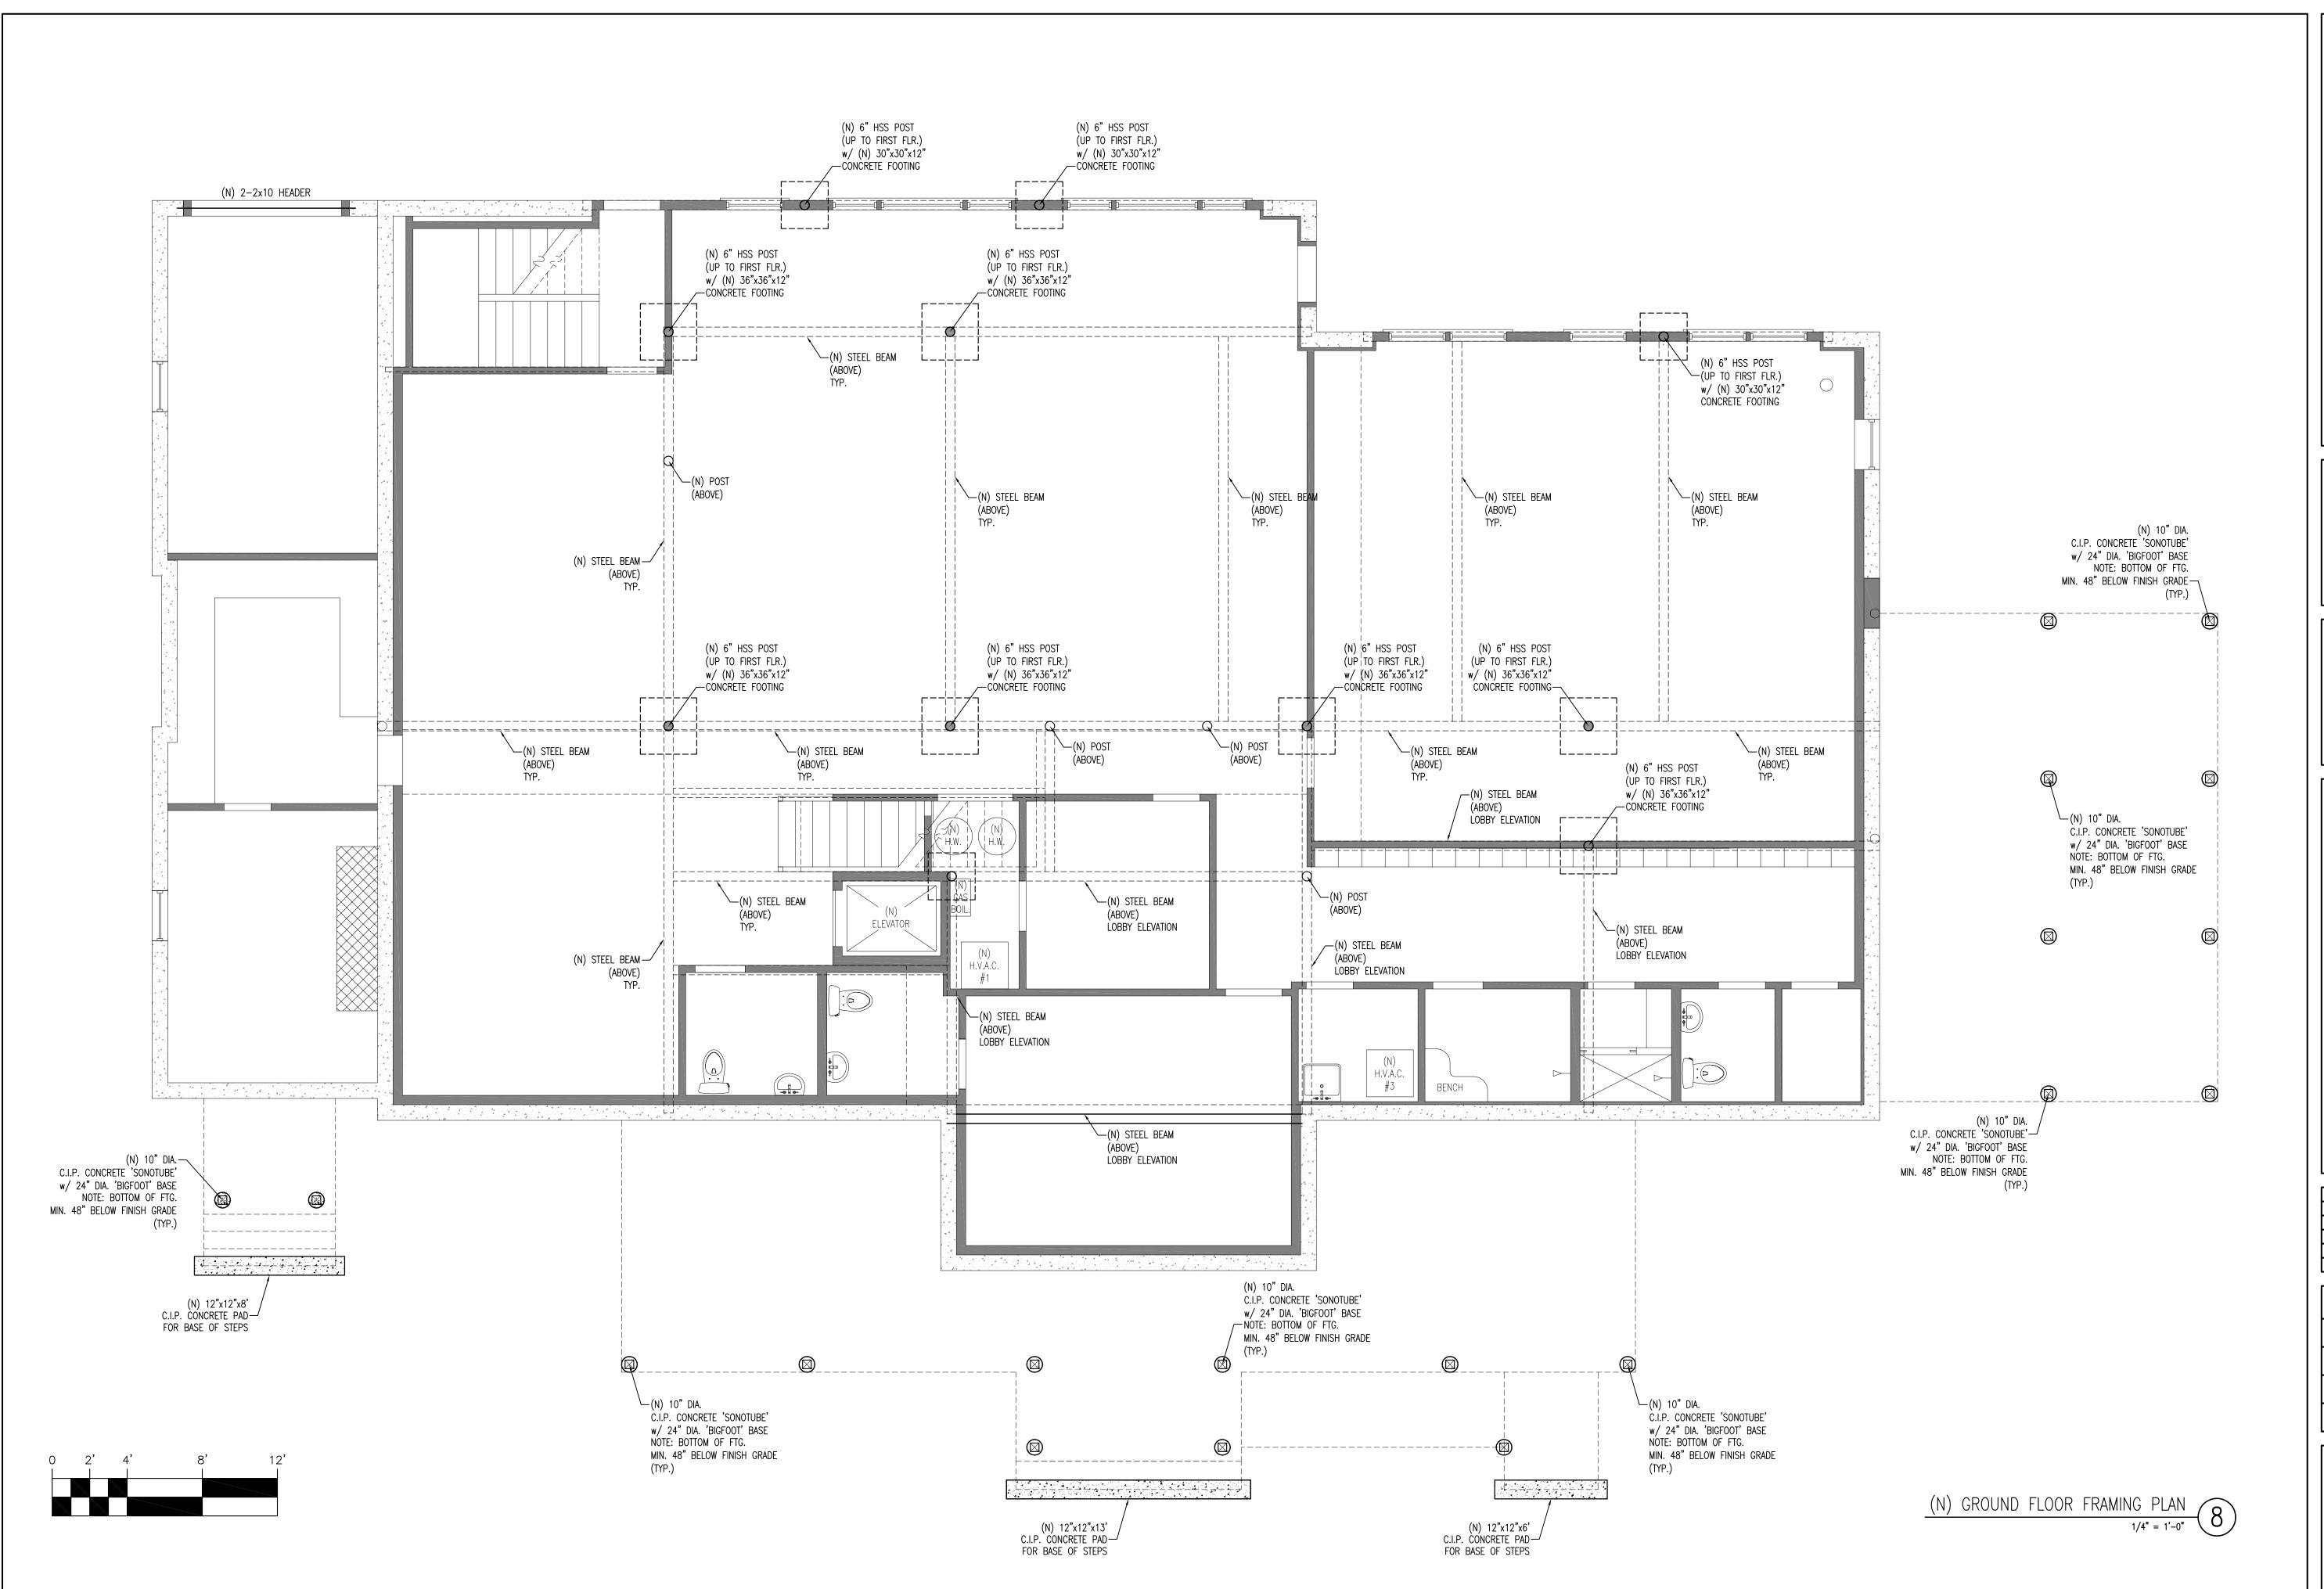EXISTING CONDITIONS FOR: 323 ORLEANS ROAL Chatham, MA 02650

REVISIONS:

GROUND

PROJECT NUMBER: -DATE: 6.16.2017


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S1




REVISIONS:

FRAM

FIRST FLOOR

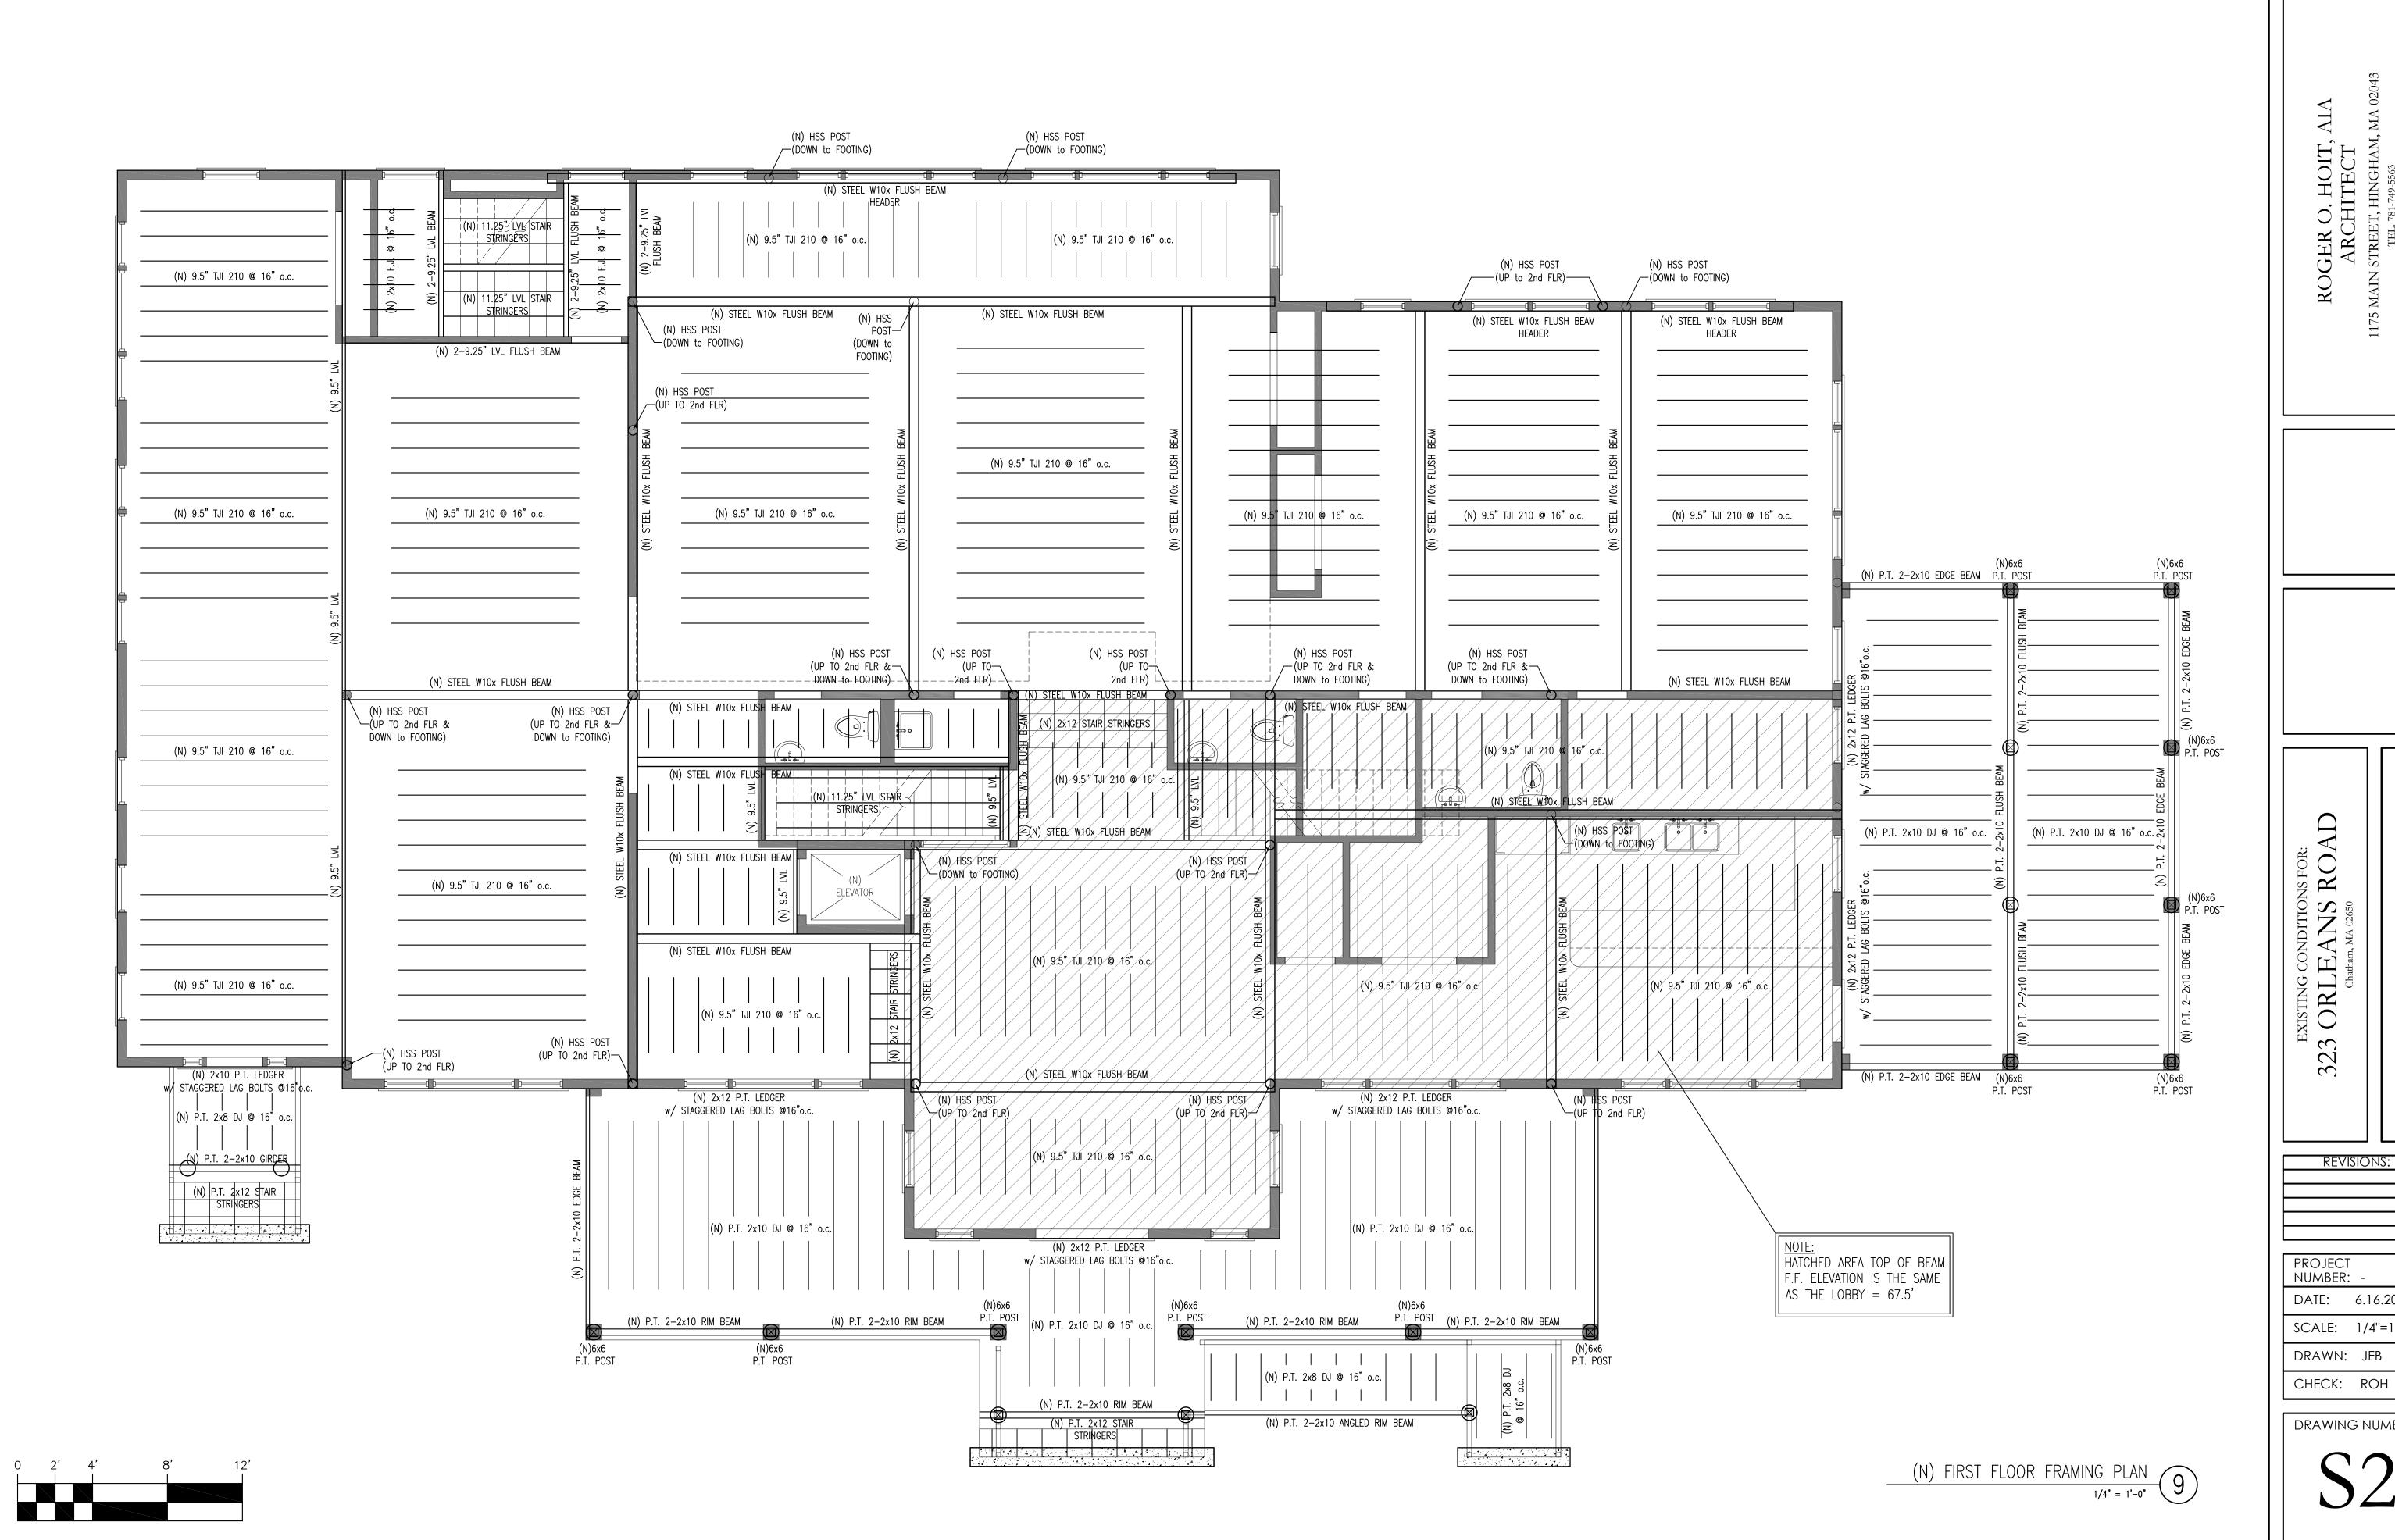DATE: 6.16.2017

SCALE: 1/4"=1'-0" DRAWN: JEB

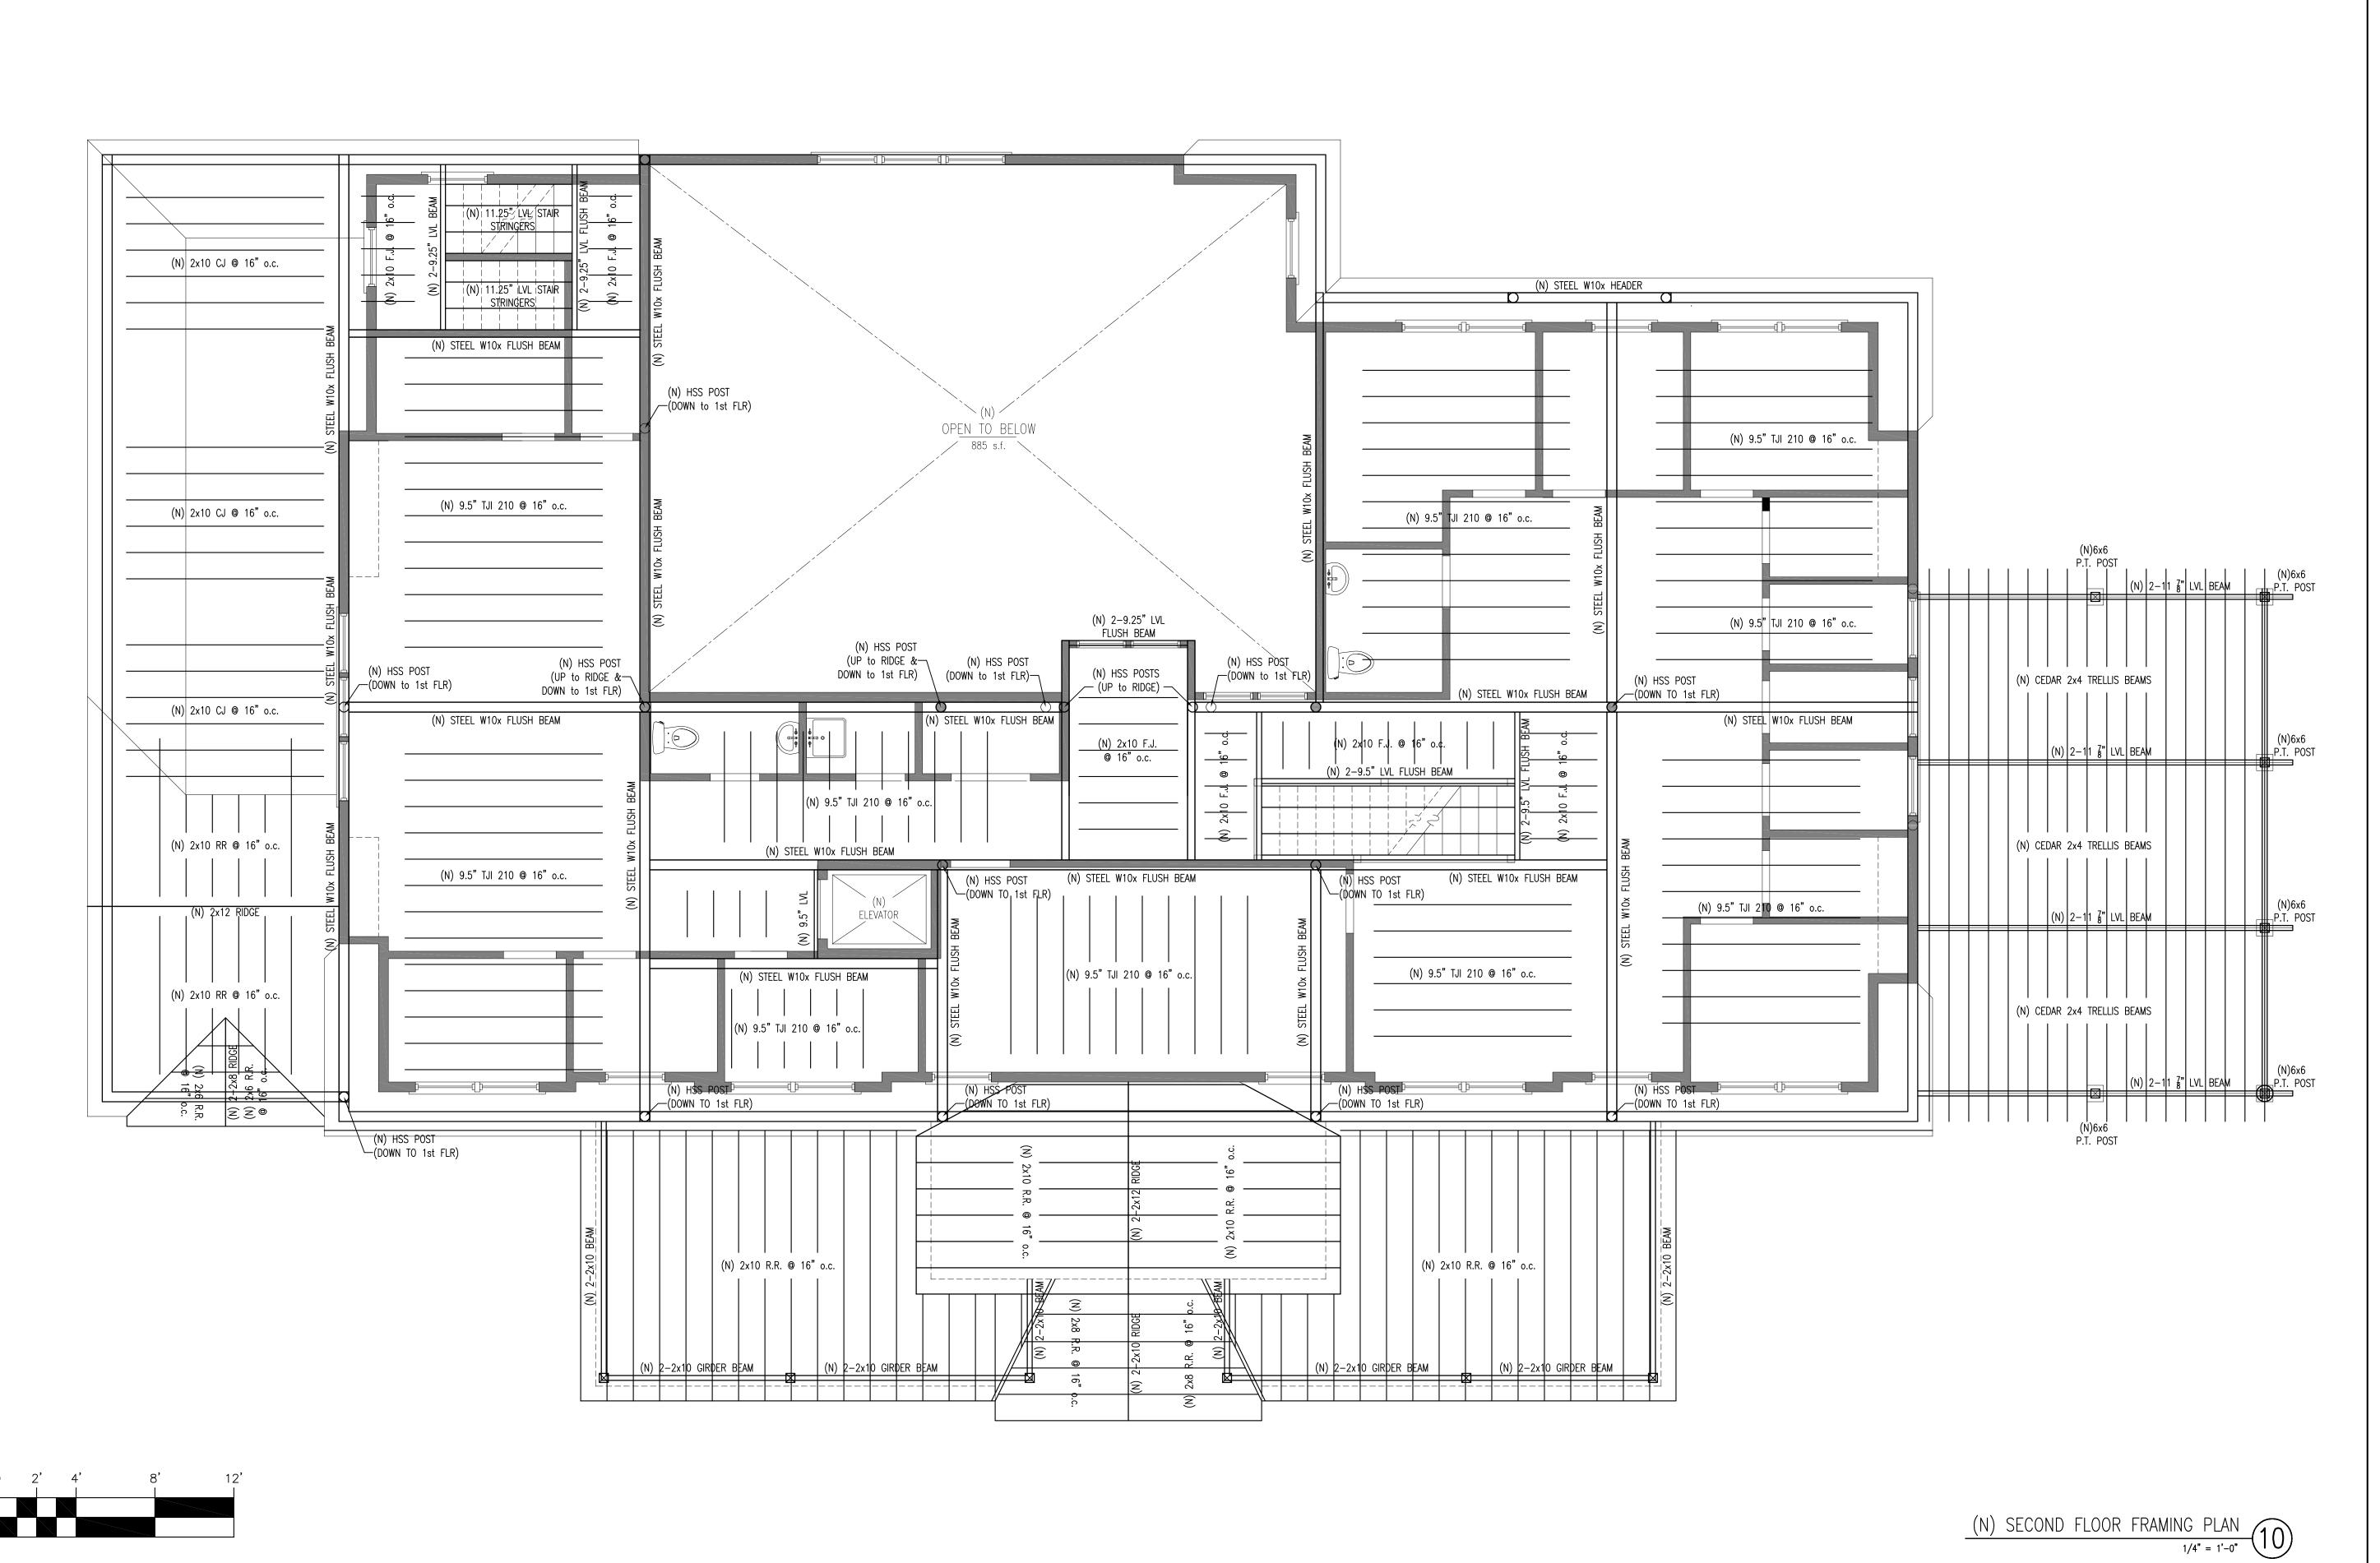

ROAD

S23 ORLEANS ROAD

Chatham, MA 02650

(N) SECOND FLOOR FRAMING F

REVISIONS:

PROJECT NUMBER: -DATE: 6.16.2017


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CHECK: ROH

DRAWING NUMBER:

S3



EXISTING CONDITIONS FOR: 323 ORLEANS ROAD Chatham, MA 02650

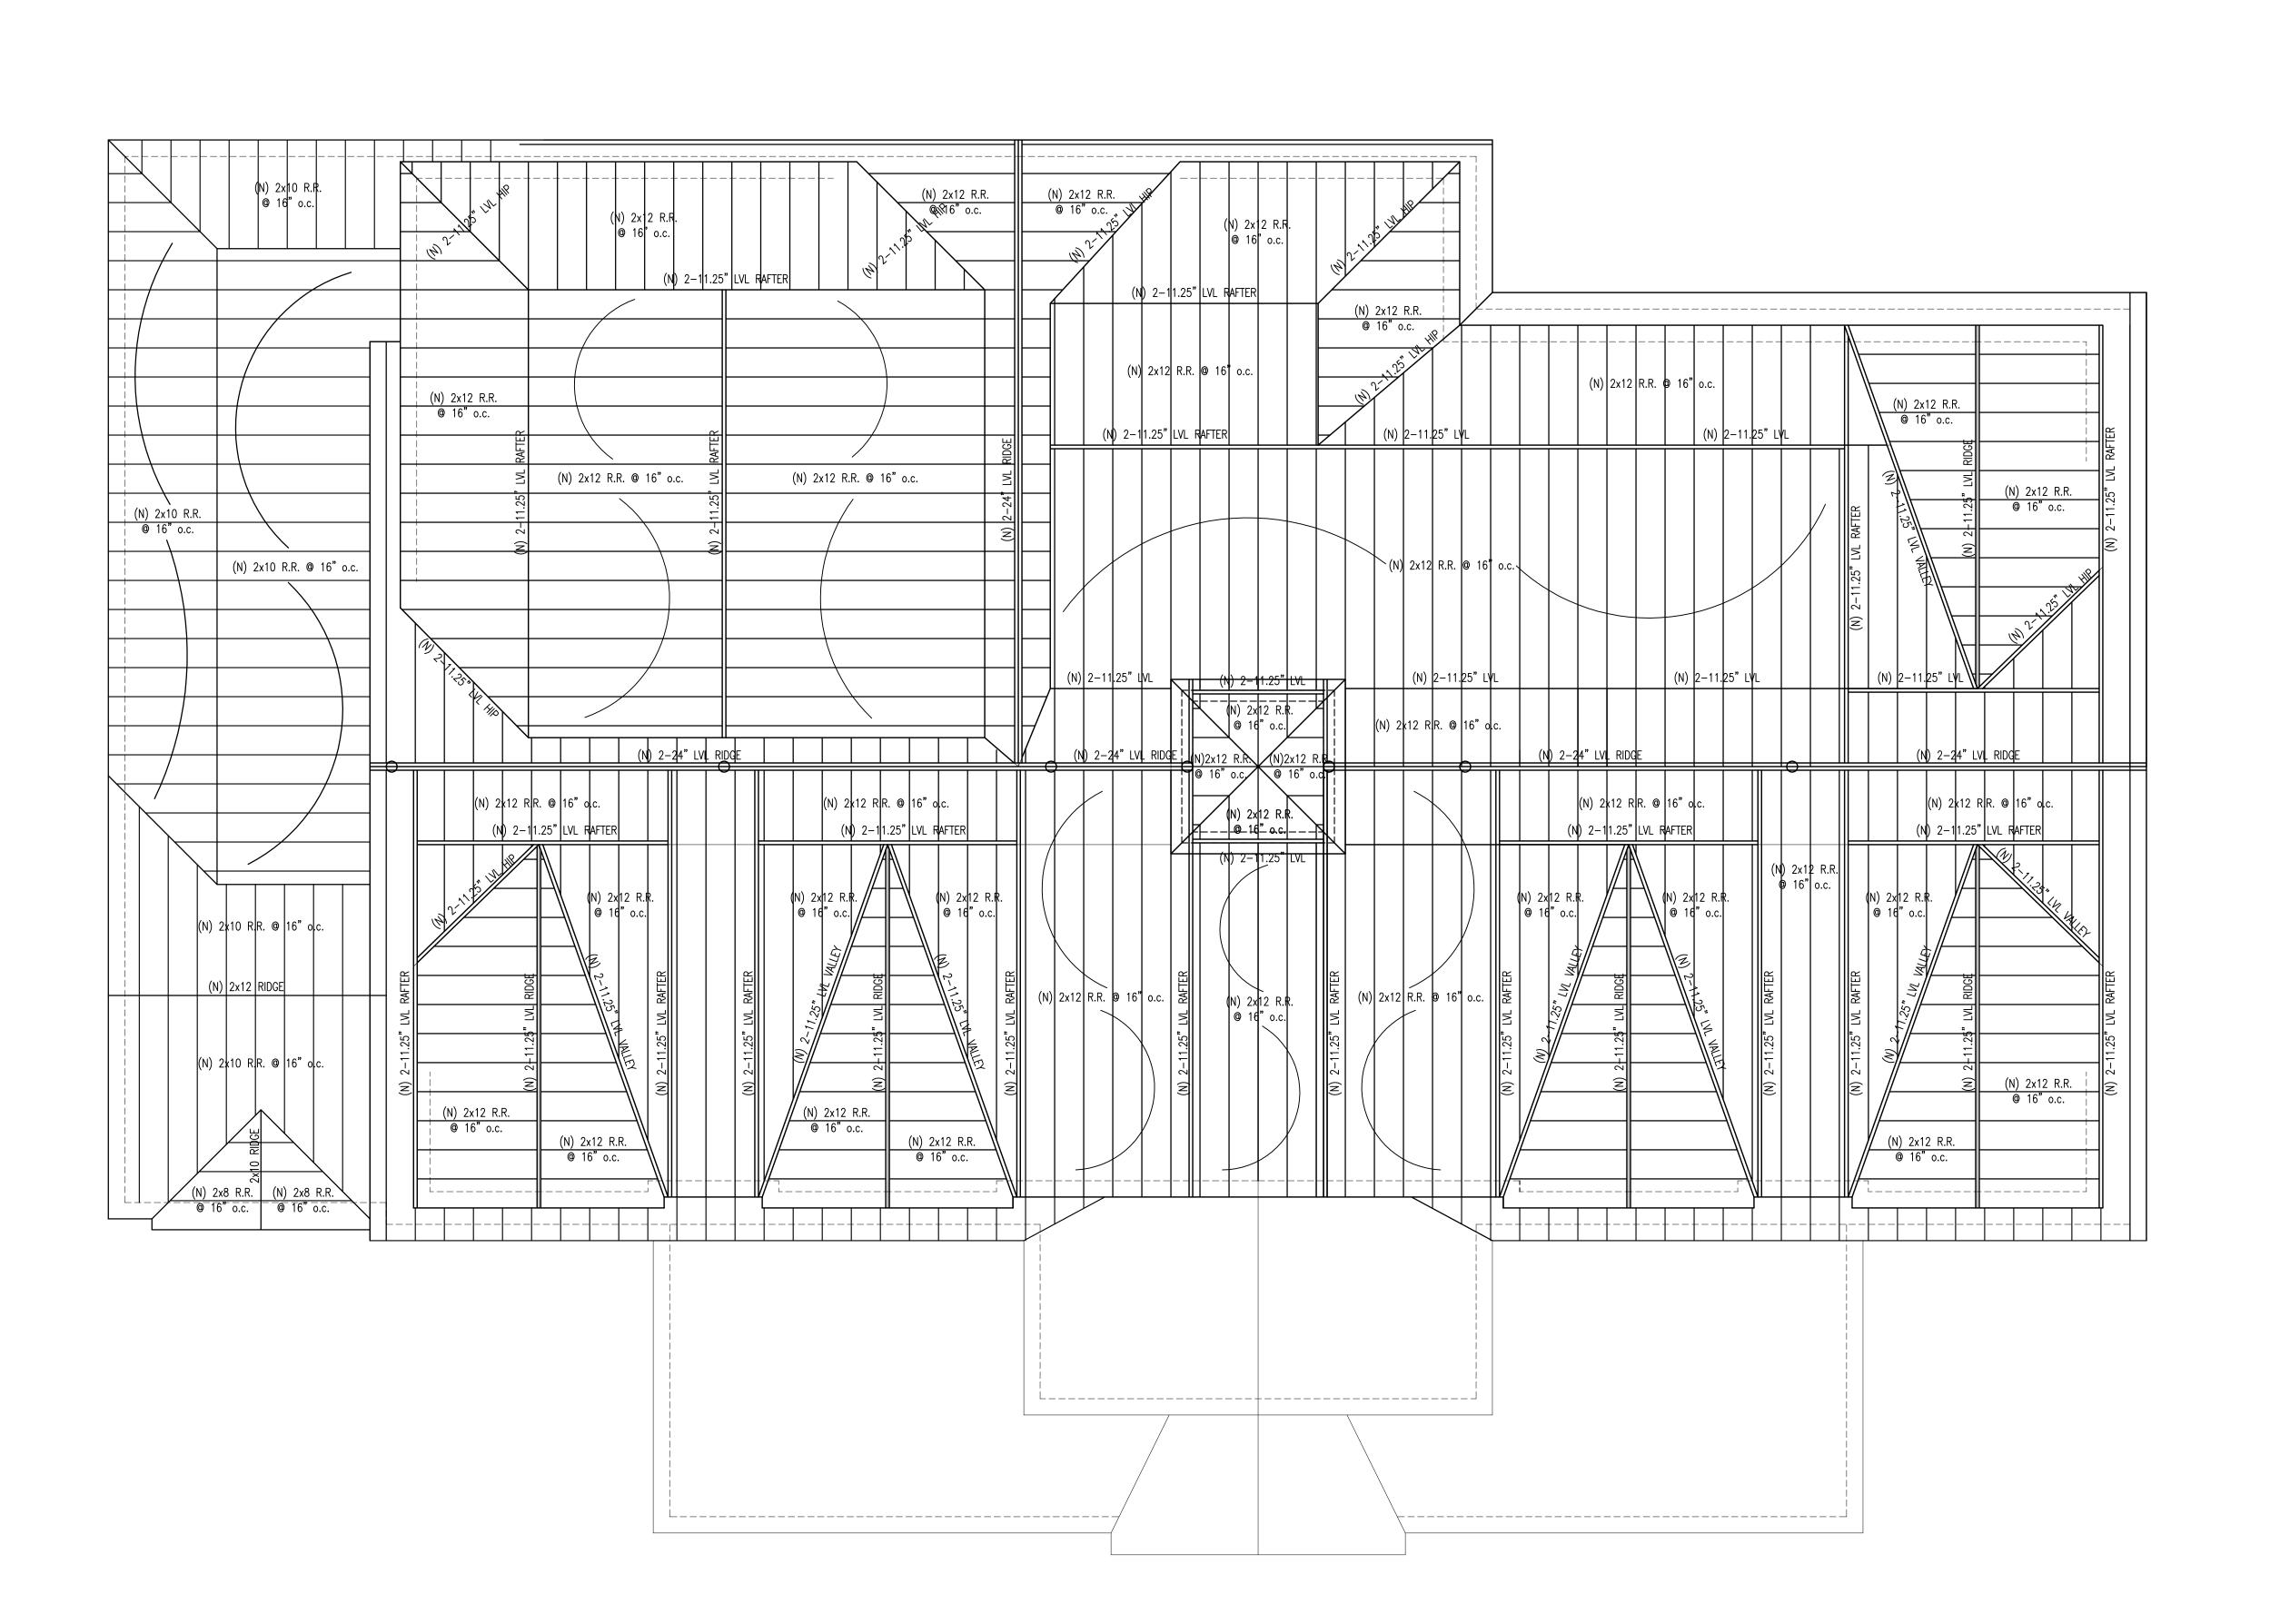(N) ROOF FRAMING PLAN

REVISIONS:

PROJECT NUMBER: -


DATE: 6.16.2017 SCALE: 1/4"=1'-0"

DRAWN: JEB

CHECK: ROH

DRAWING NUMBER:

S4

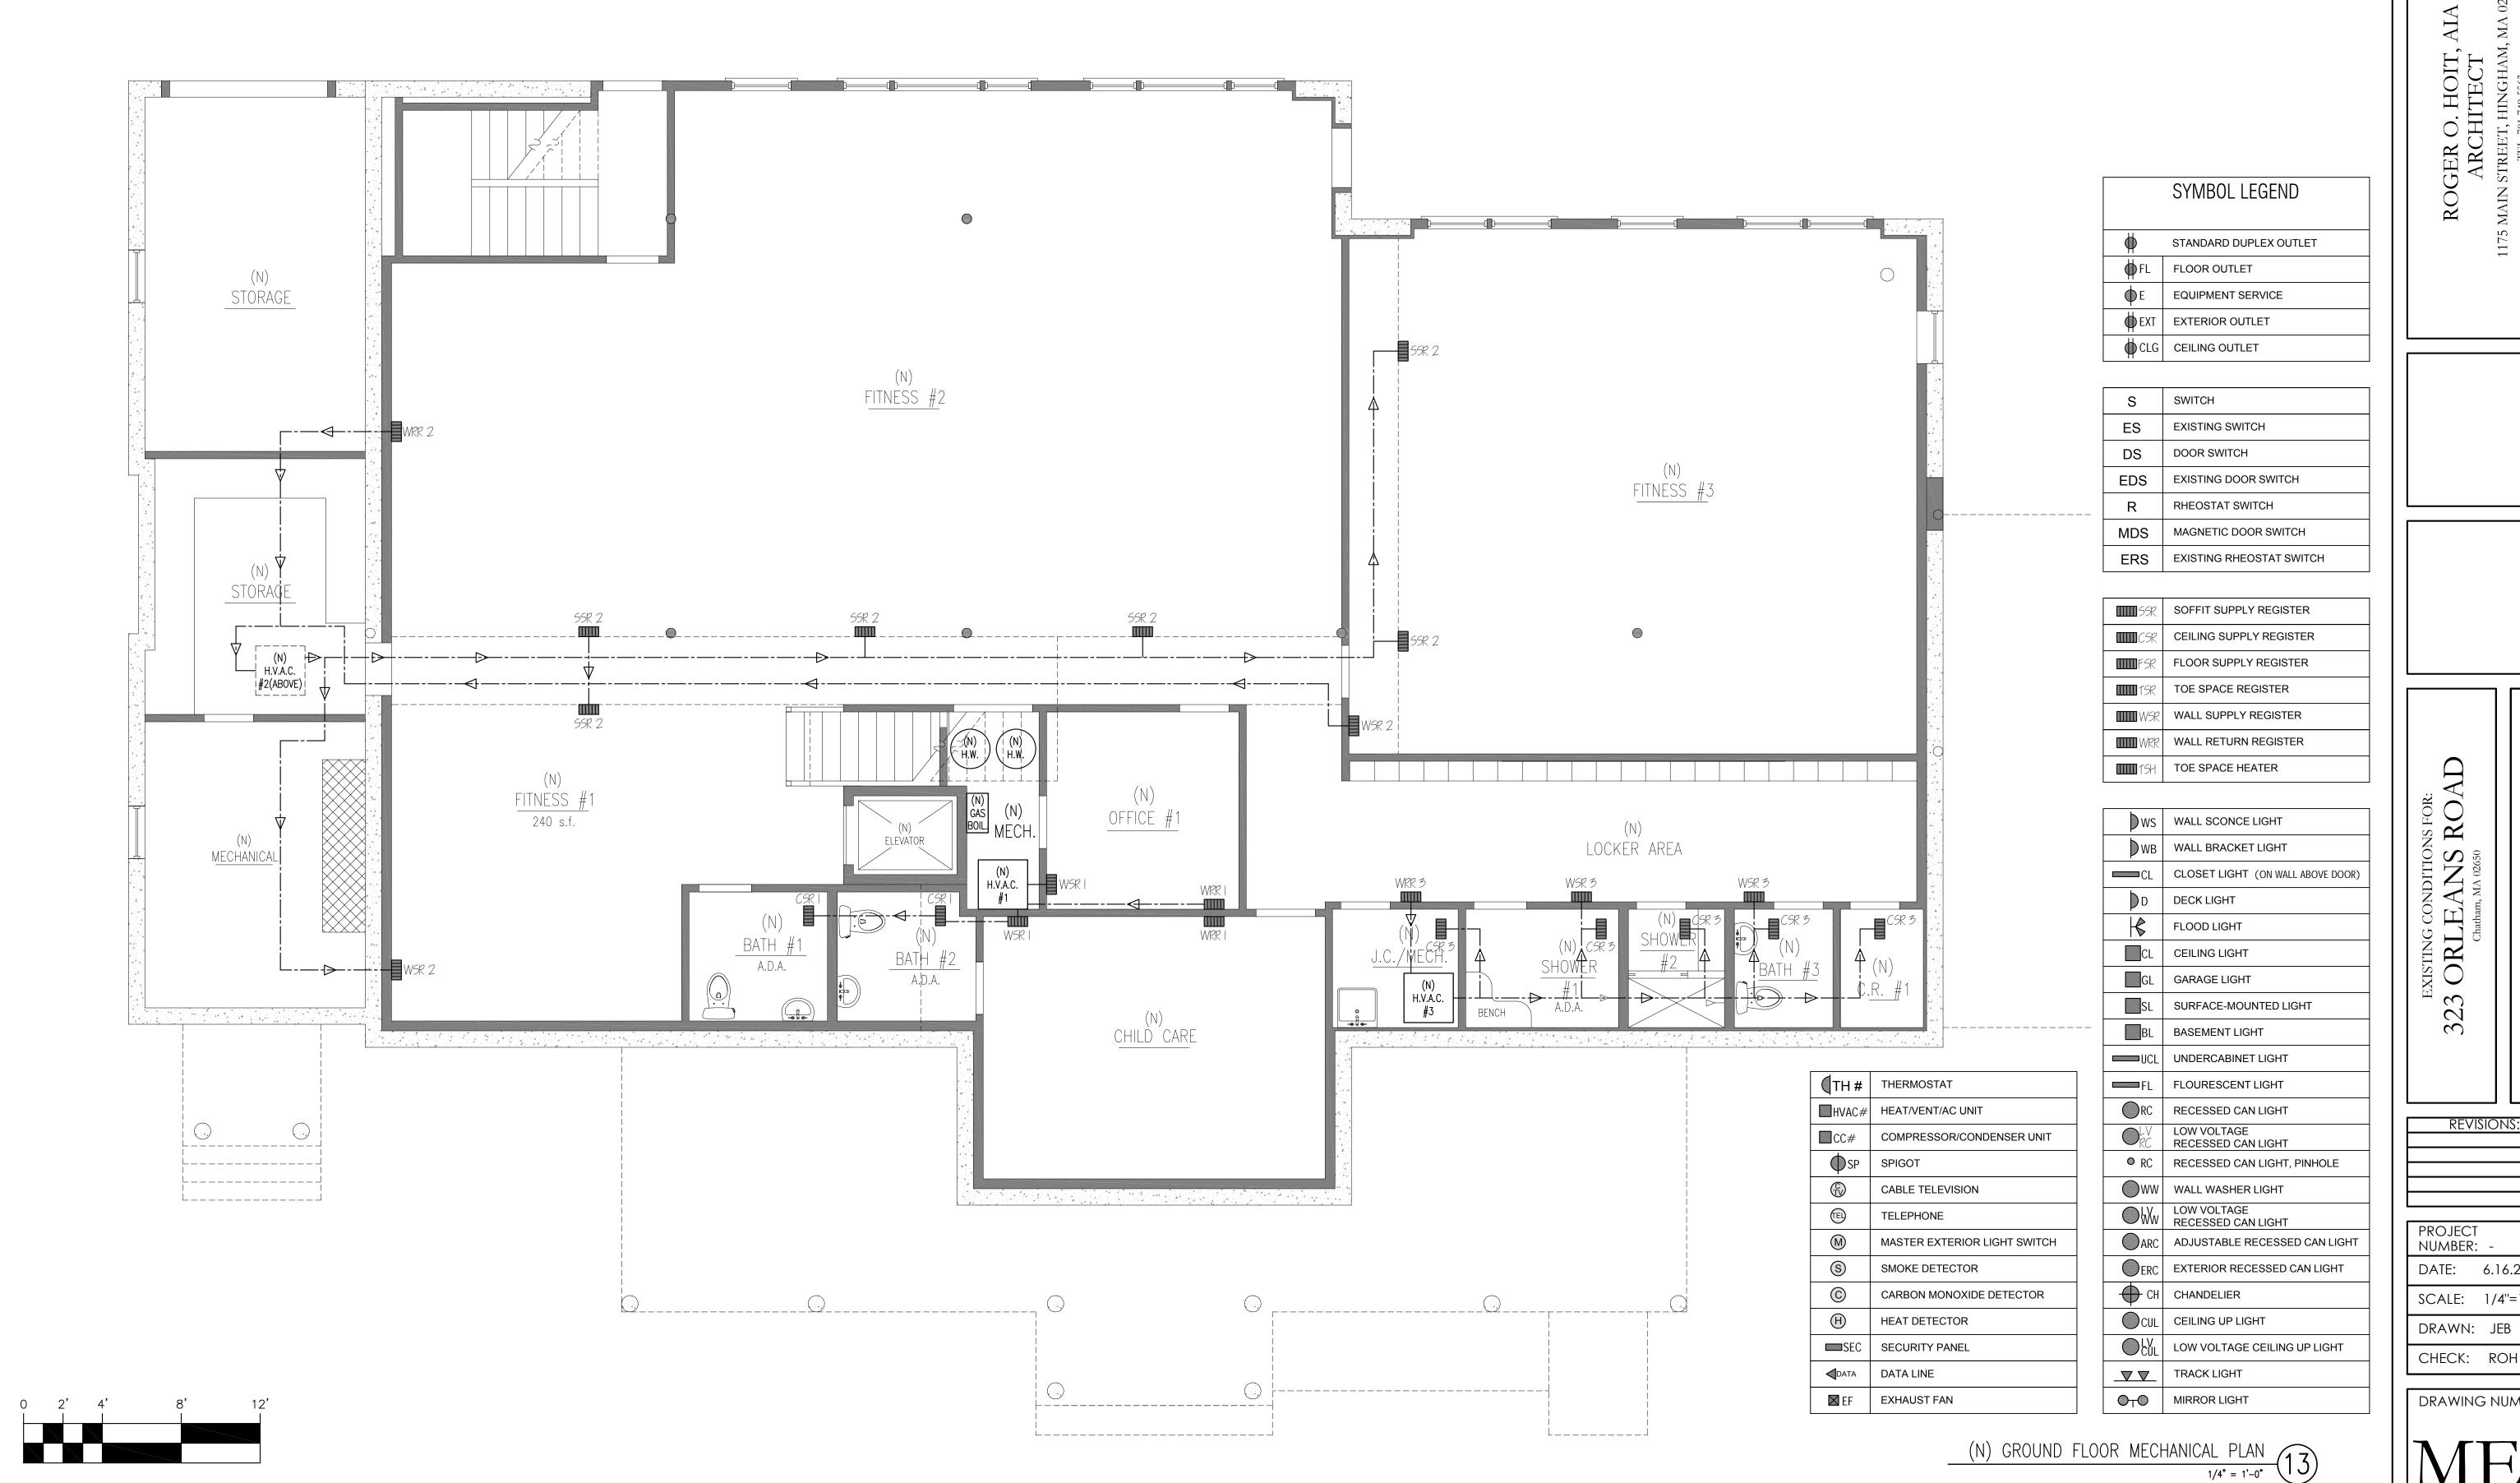

ROGER O. HOIT, AIA ARCHITECT

IS FOR:
ROAD EXISTING CONDITION:

323 ORLEANS 1

Chatham, MA 02650

REVISIONS:


FLR.

PROJECT NUMBER:

DATE: 6.16.2017 SCALE: 1/4"=1'-0"

CHECK: ROH

DRAWING NUMBER:

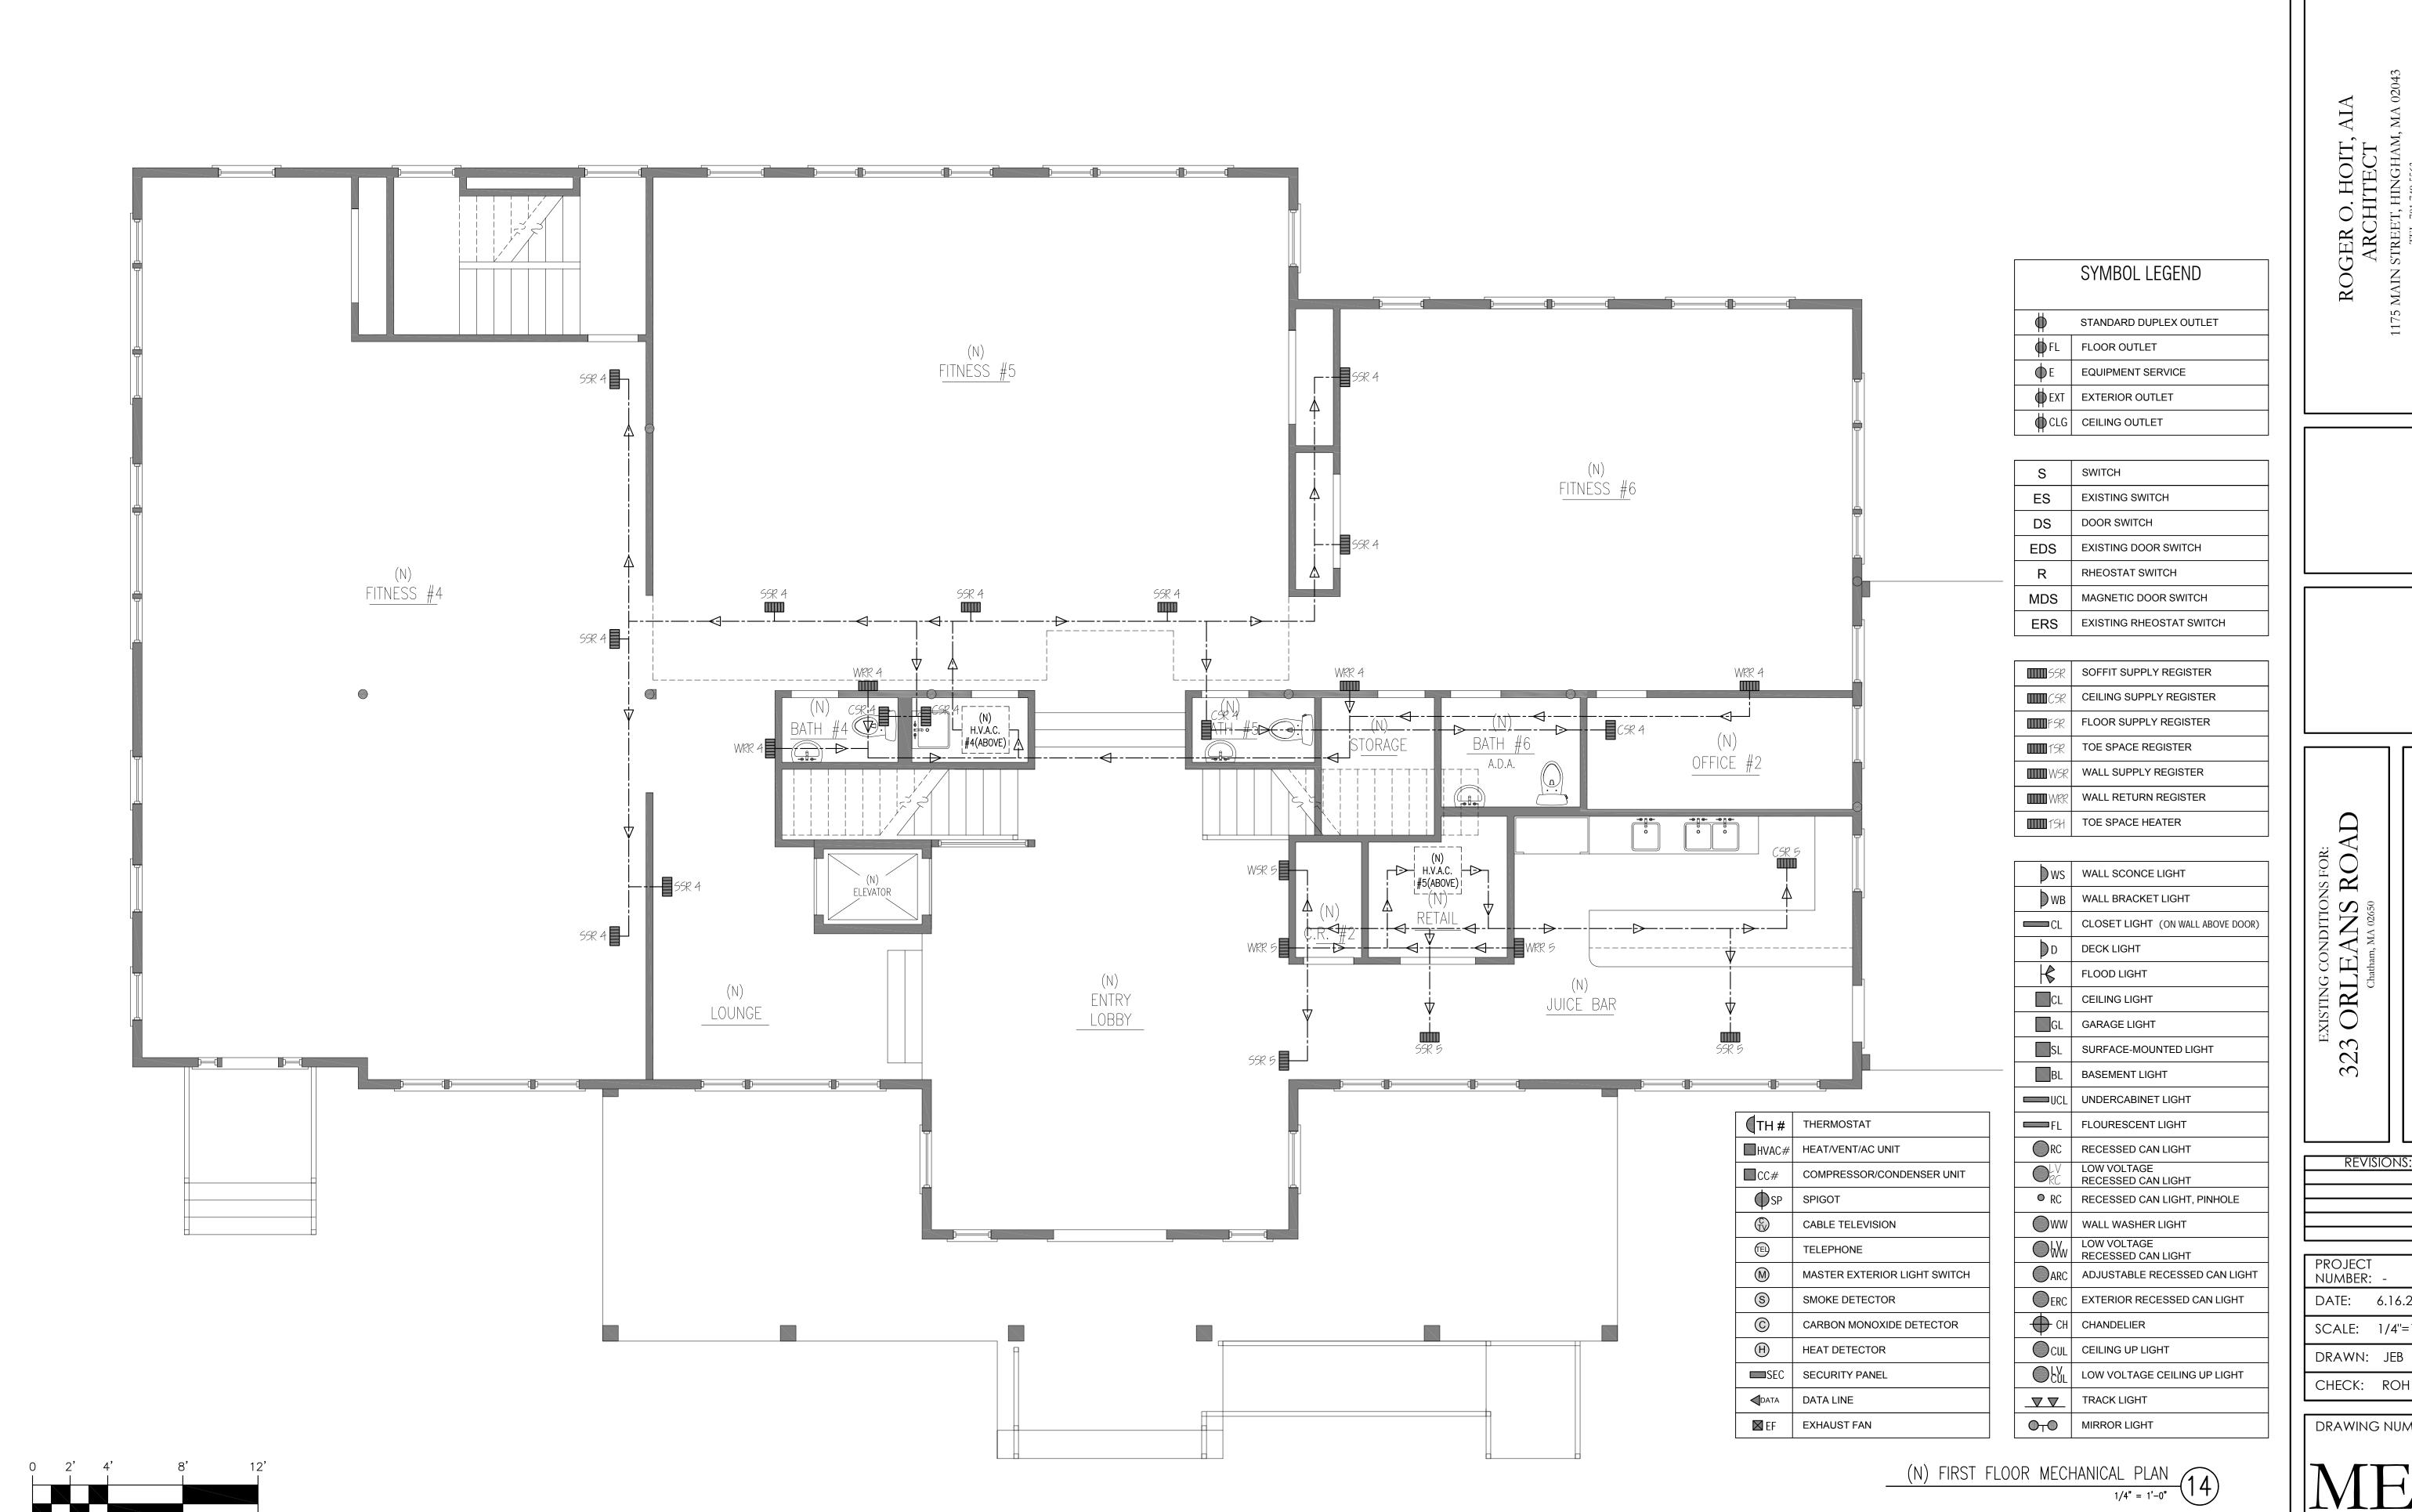

ROGER O. HOIT, AIA
ARCHITECT
5 MAIN STREET, HINGHAM, MA 020
TEL. 781-749-5563

AS FOR:
ROAD EXISTING CONDITION

323 ORLEANS

Chatham, MA 02650 MECHANICAL PLAN

FLR.


REVISIONS:

PROJECT NUMBER: -

DATE: 6.16.2017 SCALE: 1/4"=1'-0"

CHECK: ROH

DRAWING NUMBER:

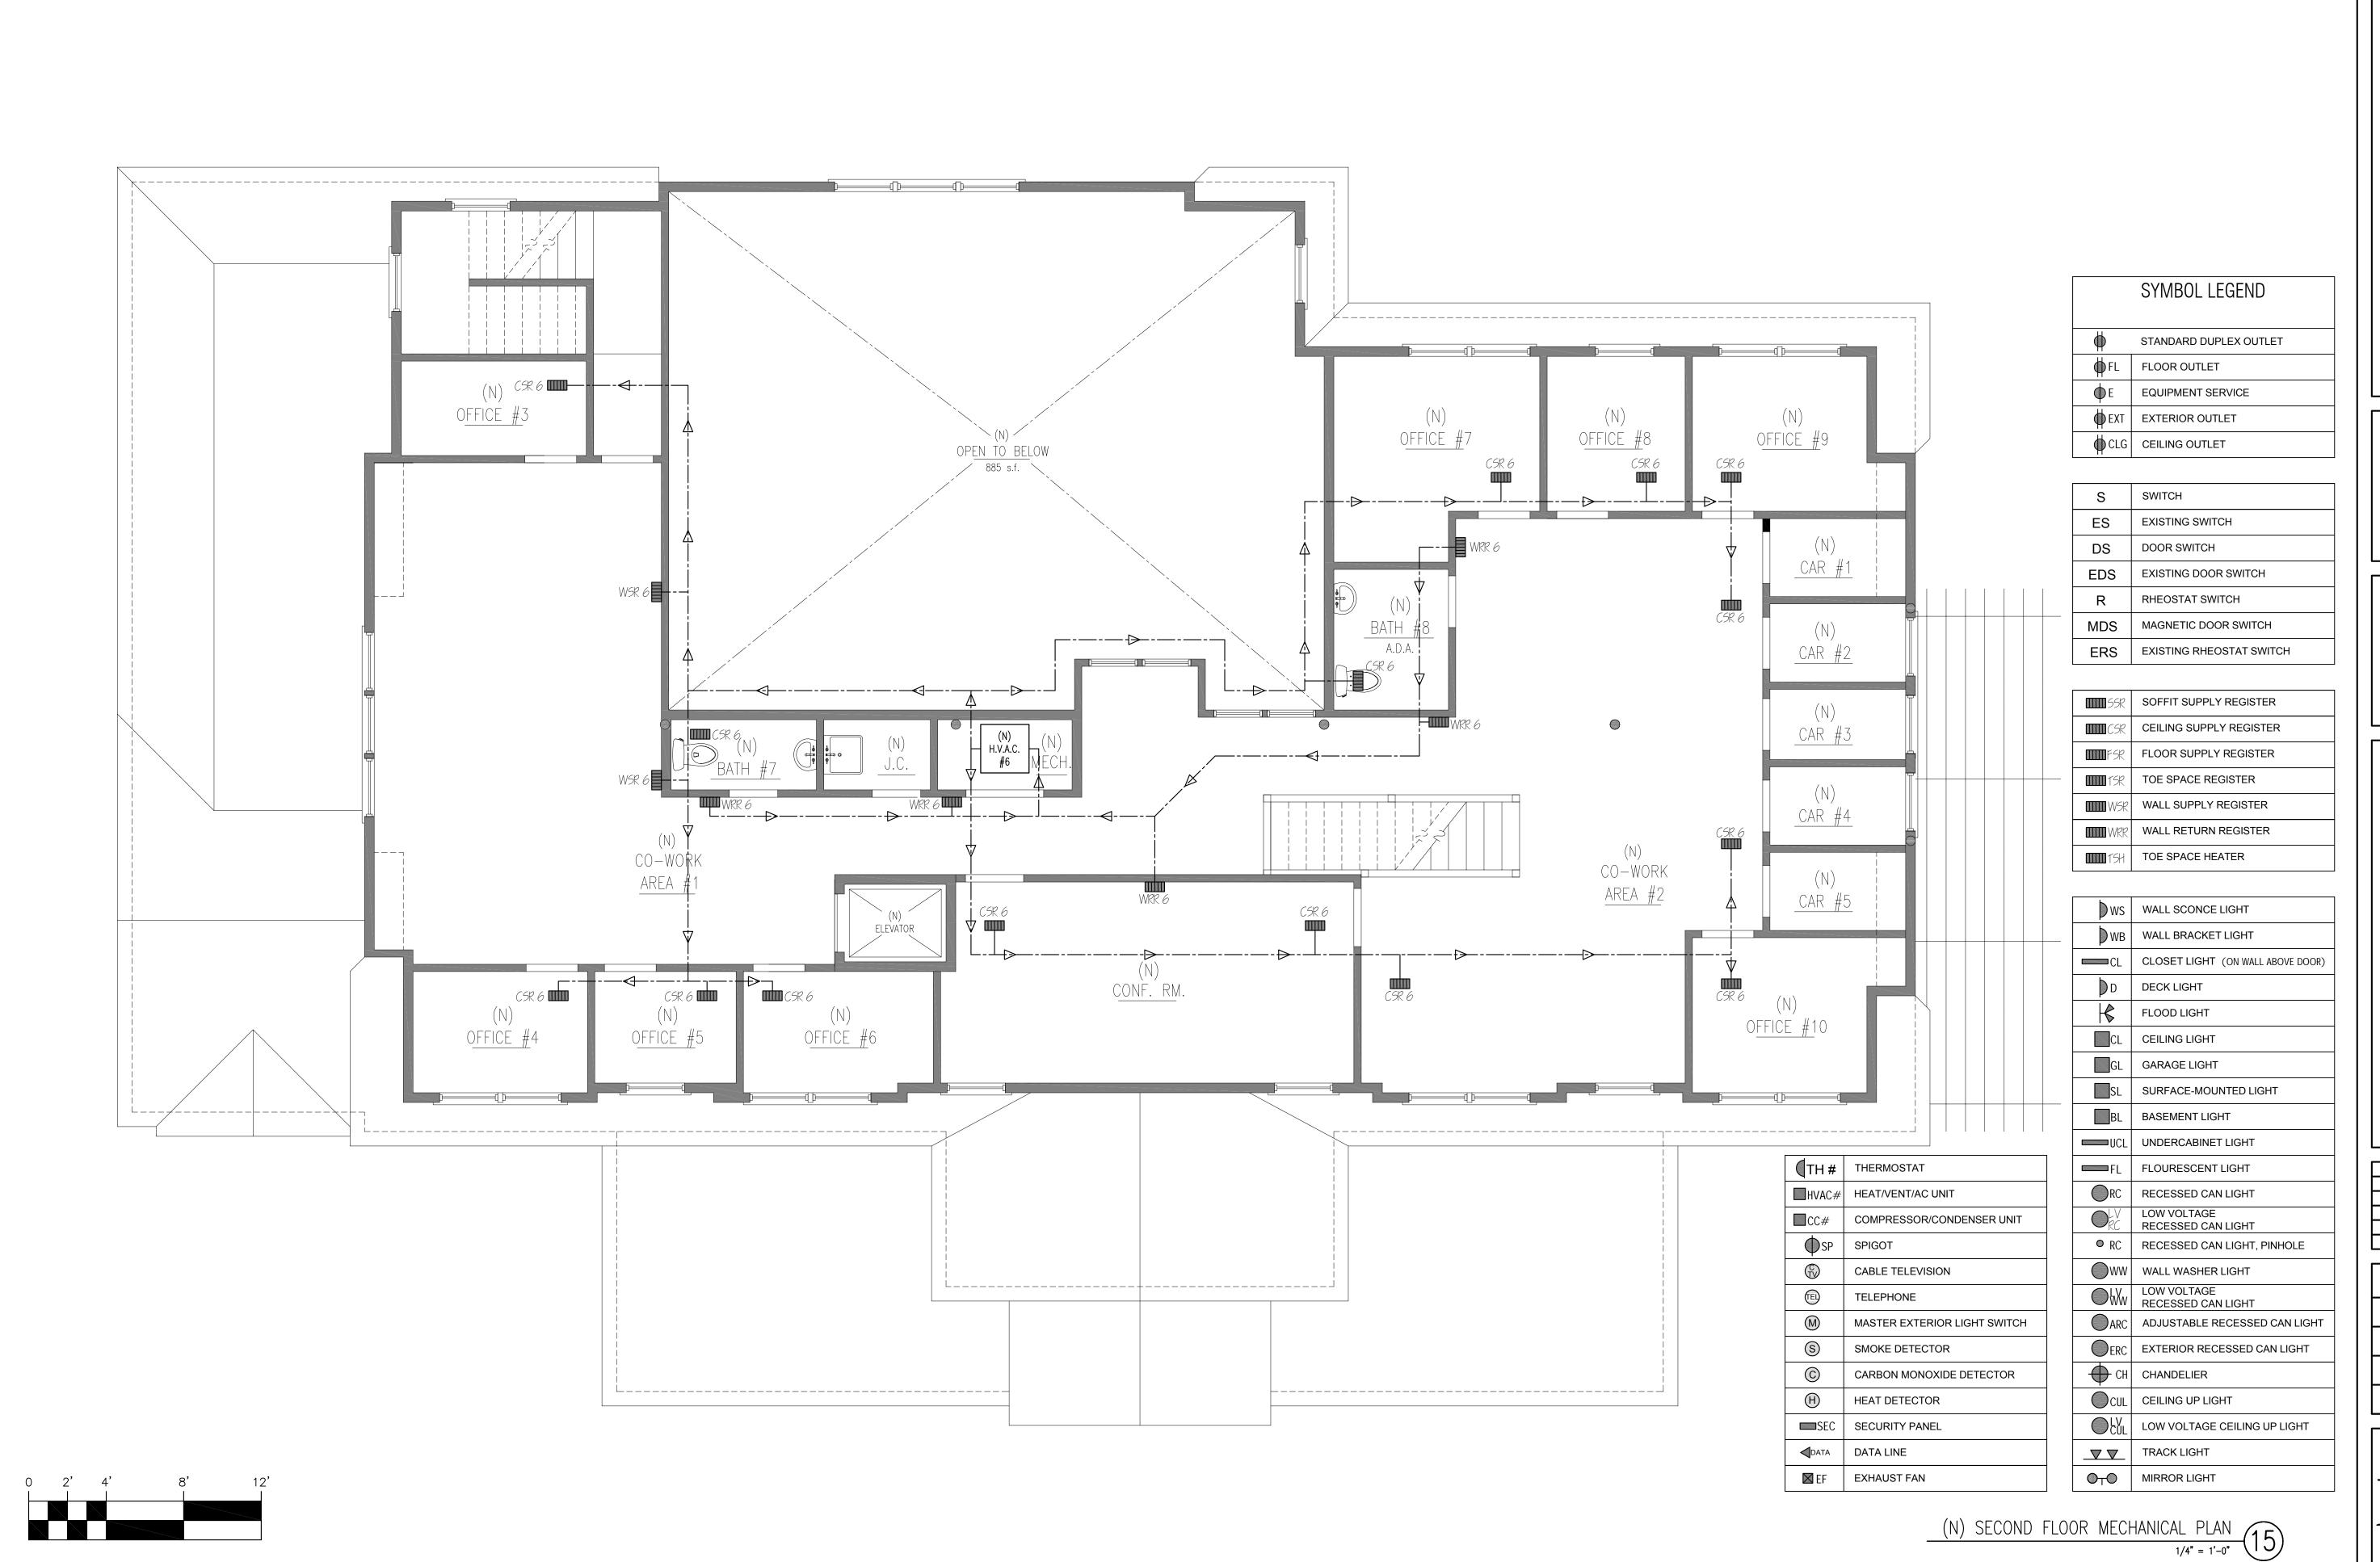

ROGER O. HOIT, AIA
ARCHITECT
1175 MAIN STREET, HINGHAM, MA 02043
TEL. 781-749-5563

EXISTING CONDITIONS FOR: 323 ORLEANS ROAD Chatham, MA 02650

REVISIONS:

SECOND

PROJECT NUMBER: -DATE: 6.16.2017

DATE: 6.16.2017

SCALE: 1/4"=1'-0"

DRAWN: JEB

CHECK: ROH

DRAWING NUMBER:

ME3



Revision #: 001

Date: 6/13/17

Scale:

1/16" = 1'

Landscape Plan: 001

Chatham Works

Landscape Design by: Al Sorbello / Val Davis

LEGEND

QTY PRICE

6 \$5.00

20 \$5.00

36 \$5.00 59 **\$**5.00 27 **\$**5.ΦΦ

12 **\$**5.00 22 **\$**5.ΦΦ

6 \$5.00

6 \$5.00

4 **\$**5.*ΦΦ*

6 \$5.00

II \$5.ΦΦ


12 \$5.00


8 \$5.00

2 \$5.00

COMMON NAME

Sorbello Landscaping Inc.

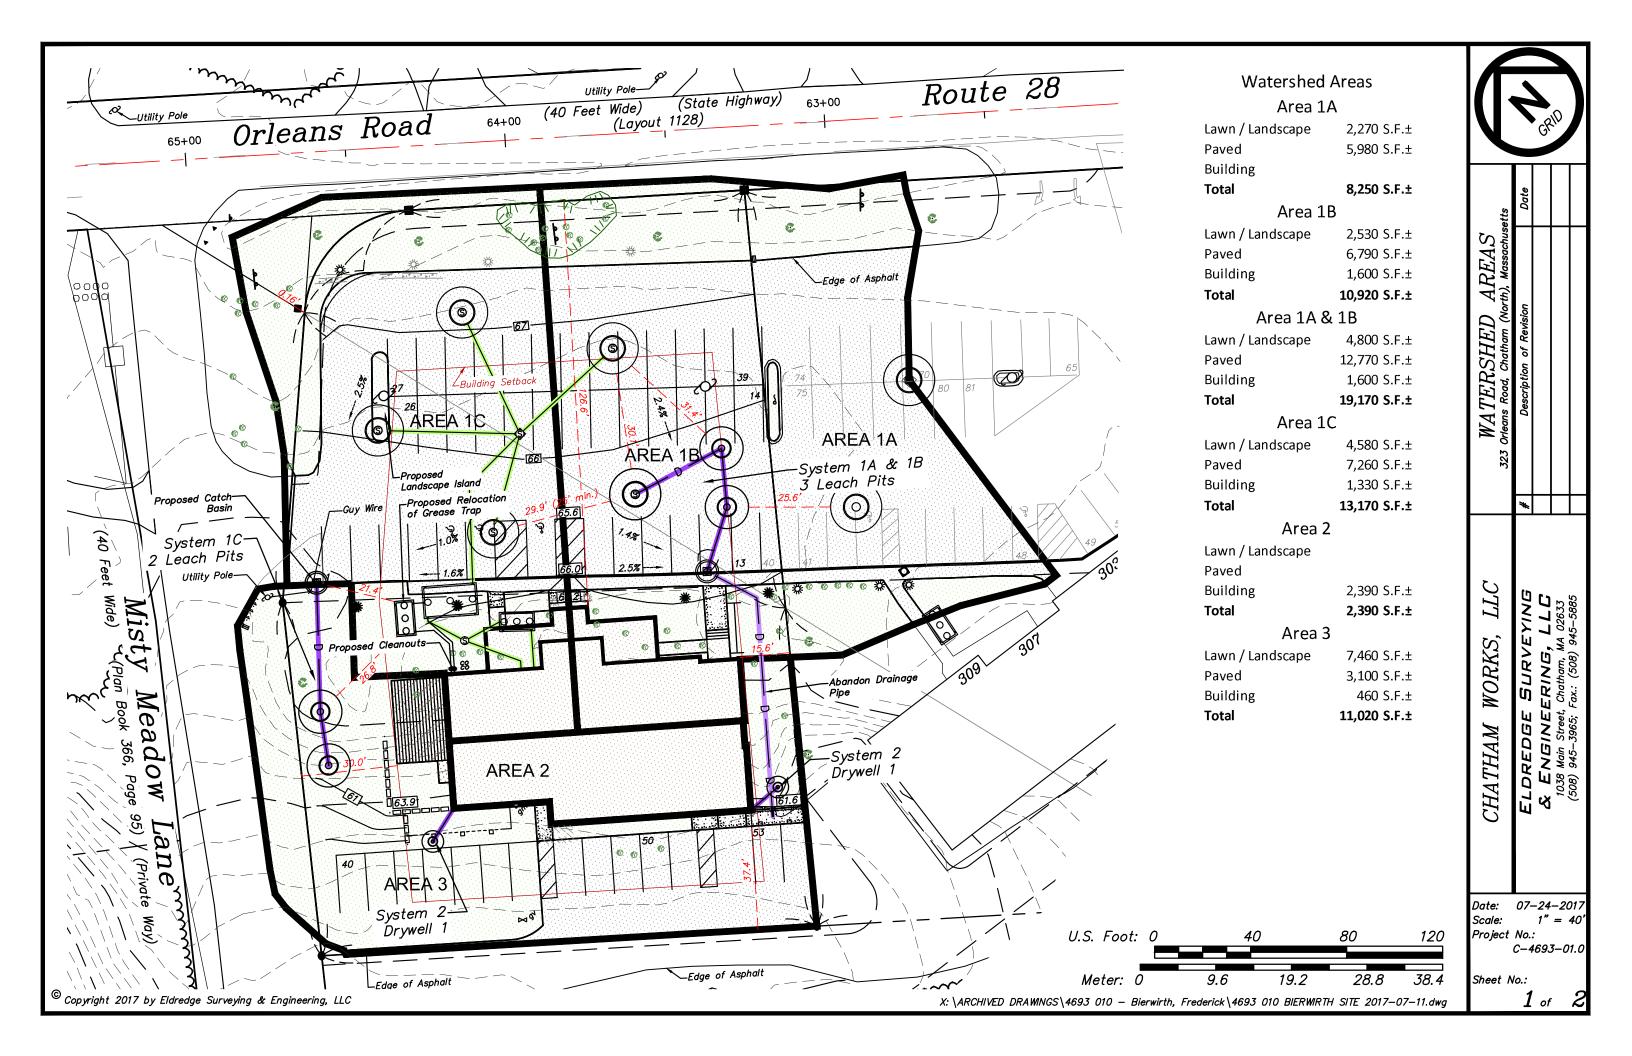

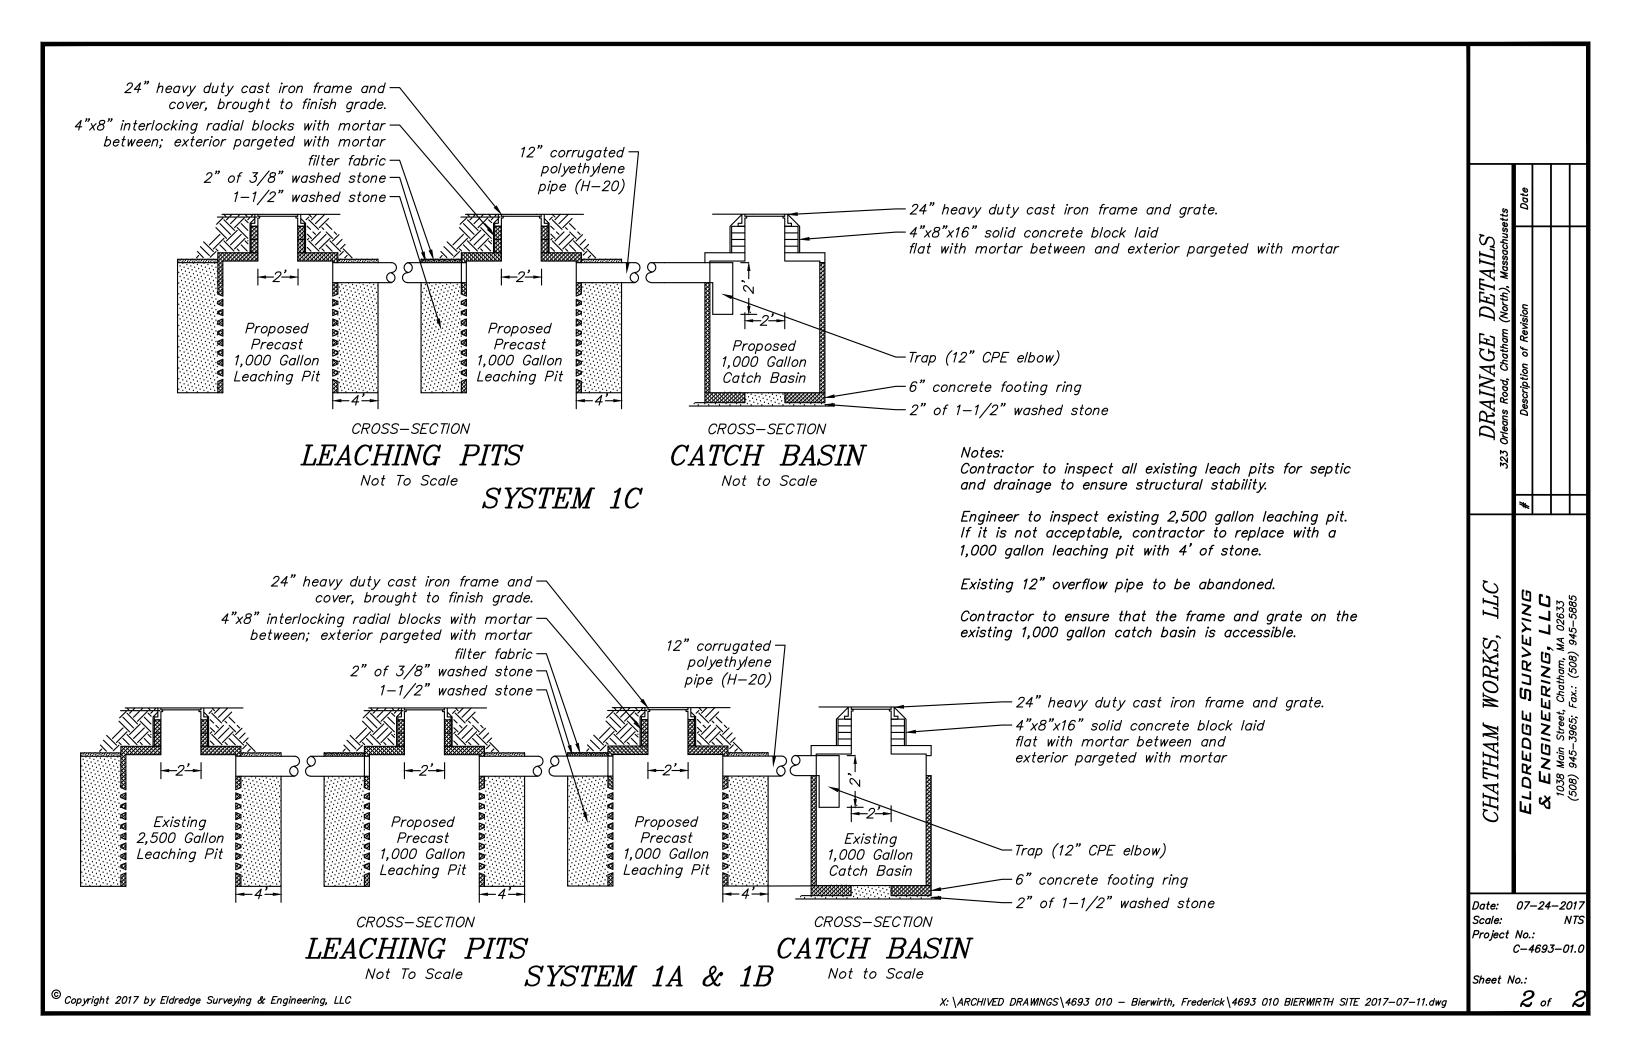

SYSTEM # Chatham Works - System 1A + 1B (to be constructed)

1. Area of contribution (A)

Impervious area:

 Pavement Area
 12770 S.F. = 0.293 Acres

 Roof Area
 1600 S.F. = 0.037 Acres

 Pervious area (Grass):
 4800 S.F. = 0.110 Acres

 Total area
 19170 S.F. = 0.440 Acres

- 2. Composite coefficient of runoff (C)
 - = (Impervious area * 0.98) + (Pervious area * 0.39) / Total area

≈ 0.83

- 3. Rainfall intensity (i) from formula: i = 230 / (time of concentration[in minutes] + 30)

 2.80 inches per hour for 60 minute duration
- 4. Average runoff (Q) = CiA in c.f. per sec. (for initial sizing of leaching facility)

= 0.83 * 2.80 in/hr * 0.44 acres = 1.0 c.f. per sec. for 60 min duration

or 61.5 c.f. per min. for 60 min duration

5. Infiltration rate of soils (permeability) from tables

= 0.70 gal per min. per s.f. / 7.5 gal per c.f.

= 0.09 c.f. per min. per s.f.

6. Infiltration area required to leach average runoff

= (Q c.f. per sec. * 60 sec per min.) / infiltration rate in c.f. per min. per s.f.

= 659 s.f. required

7. Initial sizing of system (using 6 ft dia. leach pit) to meet the required infiltration area


3 six foot diameter leaching basin(s) 6 feet deep with 4.0 feet of stone all around


8. Infiltration area, sidewalls only (actual)

= # of structures * Diameter of system * pi *depth of system

= 3 basin(s) * 14 leet * pi 6 feet deep

= 792 s.f. provided

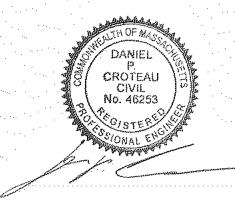

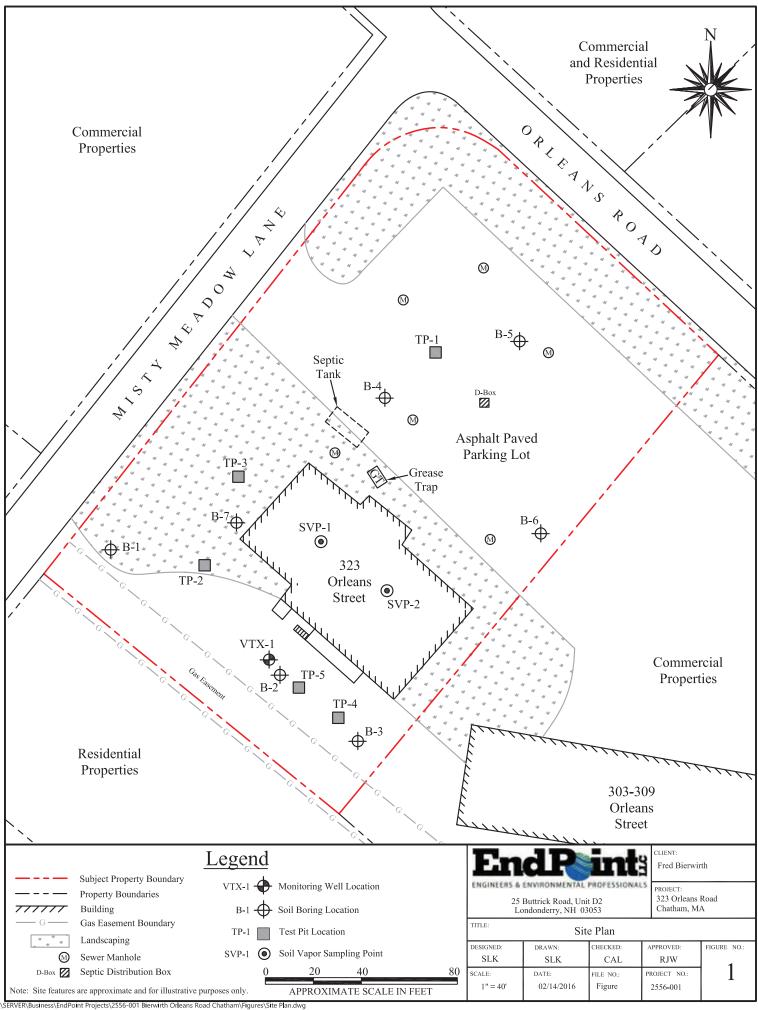



SOIL BORING LOG 323 Orleans Road Chatham, Massachusetts Drilling Utility

Drilling Co.: TDS, Inc.

Foreman:

Vehicle: Truck Rig

Model CME 75

Method: 3" Split Spoon

Sampler: 2ft

Hammer(lb): 140

Entities: 30

Well Specifications

Well Specifications

Well Matl.: NA

Well Matl.: NA

Depth(ft): NA

Screen Int.: NA

Wellhead: NA

Hammer(lb): 140

Ground Elev.: NA

Wellhead Flev.: NA

					Chatham, Massachusetts	Fall(in): 30		ellhead Elev.: NA
				(")	Boring Location:	Southwest Corner (grass area)	vve	MINGGO LICV IVA
			_	FIELD SCREENING (ppm Benzene)	WTC Coordinates: N	E		
	O	Ē	es)	e EN	Ground Surface Elevation:			
=	ohi ff)	<u>-</u>	t ś	RE zen	Date Started:	1/30/2017		WELL / STRATIGRAPHY
Ĭ	Jraj Jl (*	ζĔ	S :=	SC en:	Date Completed:	1/30/2017		DIAGRAM
L	atig	₹	w (n B	GW depth at time of installation (ft):	NA	Щ	
DEPTH (ft)	Stratigraphic Interval (ft)	PEN/REC (in)	Blow Counts (per 6" inches)	ndd ppn	SAMPLE DESCRI		NOTE	
0	0) <u>=</u>	<u> </u>	ш	F 0	SAIVII LE DESCRI	1 11011	_ _	
1 °T							1	
1 -1	0-2'	24/24	3-4-5-5	0.1	Light brown, fine SA	AND, dry		
_								
2								
1 4								
4								
			1					
	4-6'	24/14	5-3-3-5	0.1	Light brown, fine to medium SAND,	Jarge Gravel at 5-6' dry		
1 7	4-0	44/14	J-J-J-J	0.1	Light brown, the to medicili SAND,	iaige Giavei at 3-0, diy.		
			ĺ					
6			<u> </u>	\vdash				
			ĺ					
			ĺ					
1 1								
8 –								
l T								
10 –	9-11'	24/15	6-4-4-3	0.1	Light brown, fine to media	um SAND, dry.		
ΙT								
12 –	11-13'	24/16	4-3-2-6	0.1	Light brown to dark grey, fine to	medium SAND, moist.		
1 7								
					Debris (glass) a	at 13'		
14 -	13-15'	24/21	6-6-4-5	0.0	Light grey, fine to medium	n SAND, moist.		
					Yellowish orange, fine SAN			
1					Debris found a	t 13'		
16-								
1 1								
18 –								
1 1								
20 -								
l J								
1 7								
21 –								
<u> </u>								
	GRANULAF	RSOILS			COHESIVE SOILS			WELL KEY:

GRANULA	AR SUILS	COF	TESTVE SUILS
BLOWS/ft	DENSITY	BLOWS/ft	CONSISTENCY
0-4	V. LOOSE	<2	V. SOFT
4-10	LOOSE	2-4	SOFT
10-30	M. DENSE	4-8	M. STIFF
30-50	DENSE	8-15	STIFF
>50	V.DENSE	15-30	V.STIFF
		>30	HARD

WELL KEY:
RISER
SCREEN
BENTONITE
WELL SAND
FILL
PORTLAND

NOTES:

^{1.} Boring Logged by EndPoint personnel.



SOIL BORING LOG 323 Orleans Road Chatham, Massachusetts

Drilling Utility	Well Specifications
Drilling Co.: TDS, Inc.	Type: NA
Foreman:	Well Dia.: NA
Vehicle: Truck Rig	Well Matl.: NA
Model CME 75	Depth(ft): NA
Method: 3" Split Spoon	Screen Int.: NA
Sampler: 2ft	Wellhead: NA
Hammer(lb): 140	Ground Elev.: NA
Fall(in): 30	Wellhead Elev.: NA

					Chatham, Massachusetts	Hammer(lb): 140		round Elev.: NA
\vdash				(D	Boring Location:	Fall(in): 30	vve	llhead Elev.: NA
			_	ž	WTC Coordinates: N	E		
	O	(ni	Blow Counts (per 6" inches)	FIELD SCREENING (ppm Benzene)	Ground Surface Elevation:	-		
⊋	£ Phi	i.	는 H	:RE	Date Started:	1/30/2017		WELL / STRATIGRAPHY
DEPTH (ft)	Stratigraphic Interval (ft)	PEN/REC (in)] 정 :E	SC	Date Completed:	1/30/2017		DIAGRAM
P	atig erve	N N	× 19	9 8	GW depth at time of installation (ft):	NA	끧	
E	Stra	Ä	De G	필요	SAMPLE DESCRIP		NOTE	
0	<i>o,</i> =				5, iiii 22 52501.iii		$\overline{}$	
							1	
	0-2'	24"/17"	6-7-8-8	0.0	Yellowish-orange, fine to med	dium CAND day		
1 7	0-2	24 / 1 /	0-7-0-0	0.0	reliowish-brange, line to med	dulli SAND, dry.		
2								
1 1								
4								
1 4	4-6'	24"/23"	23-6-5-7	0.0	Similar to abov	re.		
	. 0	2.720	2000.	0.0		.		
1.1								
6							1	
1 4	6-8'	24"/18"	7-10-7-7	0.0	Light brown to dark grey, fine to medium SAND, some	e fine Gravei. Glass and plastic debris at		
					7'			
8								
	Debris found at 7'					: 7'		
1 1								
40								
10-								
1 4								
12-								
'~								
1 1								
14 -								
1 7								
16 –								
1]								
1 1								
1								
18-								
1 4								
								! !
								! !
20 –								
								! !
1 1								
21 –								
1 - 1								
1 1								

GRANUL	AR SUILS	COHESI	COHESIVE SOILS		
BLOWS/ft	DENSITY	BLOWS/ft	CONSISTENCY		
0-4	V. LOOSE	<2	V. SOFT		
4-10	LOOSE	2-4	SOFT		
10-30	M. DENSE	4-8	M. STIFF		
30-50	DENSE	8-15	STIFF		
>50	V.DENSE	15-30	V.STIFF		
		>30	HARD		

NOTES:

1. Boring Logged by EndPoint personnel.



SOIL BORING LOG 323 Orleans Road Chatham, Massachusetts

Drilling Utility	Well Specifications
Drilling Co.: TDS, Inc.	Type: NA
Foreman:	Well Dia.: NA
Vehicle: Truck Rig	Well Matl.: NA
Model CME 75	Depth(ft): NA
Method: 3" Split Spoon	Screen Int.: NA
Sampler: 2ft	Wellhead: NA
Hammer(lb): 140	Ground Elev.: NA
Fall(in): 30	Wellhead Elev.: NA

					Chatham, Massachusetts	Hammer(lb): 140		round Elev.: NA
\vdash				(D	Boring Location:	Fall(in): 30	vve	llhead Elev.: NA
			_	ž	WTC Coordinates: N	E	ł	
	O	(ni	s es)	e E	Ground Surface Elevation:	-	1	
₽	f)	i)	t š	RE	Date Started:	1/30/2017	l	WELL / STRATIGRAPHY
Ξ	graf al (i	ZE(] 정 :E	SC	Date Completed:	1/30/2017	1	DIAGRAM
PT	atig	Ž	w (U B u	GW depth at time of installation (ft):	NA	世	
DEPTH (ft)	Stratigraphic Interval (ft)	PEN/REC (in)	Blow Counts (per 6" inches)	FIELD SCREENING (ppm Benzene)	SAMPLE DESCRIF		NOTE	
0	<i>o,</i> =				0, mil 22 82001.m			
							1	
	0-2'	24"/21"	9-9-11-9	0.0	Yellowish-orange, fine to me	dium CAND, day		
1 7	0-2	24 /2 1	9-9-11-9	0.0	reliowish-orange, fine to men	didili SAND, dry.		
2-							ł	
lJ								
4 –							1	
1 4	4-6'	24"/18"	4-3-2-4	0.1	Similar to abov	re.		
1.1								
6-							1	
1 4	6-8'	24"/4"	3-4-4-3	0.0	Light brown to dark grey, fine to medium SAND, some	e fine Gravel. Glass and plastic debris at		
					7'			
8-								
٦					Debris found a	: 7'		
10 -								
1 4								
12-								
12-								
1 1								
14 -								
1 1								
16-								
1 1								
18 –								
								! !
1 1								! !
20 -								! !
								! !
1 -								! !
24								
21 –								
1								

GRANULA	AR SOILS	COHESIVE SOILS			
BLOWS/ft	DENSITY	BLOWS/ft	CONSISTENCY		
0-4	V. LOOSE	<2	V. SOFT		
4-10	LOOSE	2-4	SOFT		
10-30	M. DENSE	4-8	M. STIFF		
30-50	DENSE	8-15	STIFF		
>50	V.DENSE	15-30	V.STIFF		
		>30	HARD		

NOTES:

1. Boring Logged by EndPoint personnel.



SOIL BORING LOG 323 Orleans Road Chatham, Massachusetts

Drilling Utility	Well Specifications
Drilling Co.: TDS, Inc.	Type: NA
Foreman:	Well Dia.: NA
Vehicle: Truck Rig	Well Matl.: NA
Model CME 75	Depth(ft): NA
Method: 3" Split Spoon	Screen Int.: NA
Sampler: 2ft	Wellhead: NA
Hammer(lb): 140	Ground Elev.: NA
Fall(in): 30	Wellhead Flev · NA

						Fall(in): 30	We	Ilhead Elev.: NA
				NG	Boring Location:			
	0	_	(8)	EN (e	WTC Coordinates: N Ground Surface Elevation:	E	1	
£	æ)	.≡	che	REF	Date Started:	1/30/2017	1	WELL / STRATIGRAPHY
Ī	јгар al (1	Ä	_ ਨੂੰ ਦ	SCI	Date Completed:	1/30/2017		DIAGRAM
F	atig erve	N N	w 0	LD n	GW depth at time of installation (ft):	NA	끧	
DEPTH (ft)	Stratigraphic Interval (ft)	PEN/REC (in)	Blow Counts (per 6" inches)	FIELD SCREENING (ppm Benzene)	SAMPLE DESCRIP		NOTE	
0								
							1	
1 4	0-2'	24/20	10-11-14-	0.0	Light brown, fine to medium SAN	D. trace gravel, drv.		
	-		14		3 ,	, , , , , ,		
2								
1 4							1	
1 1								
4							1	
1 4	4-6'	24/24	11-11-11-	0.1	4'-5': Similar to a			
	. •		14	0	5'-6': Yellowish-orange, coarse SAND, so	me fine to coarse Gravel, dry.		
							1	
6							1	
							1	
1 1							1	
8-								
1 4								
10								
	10-12'	24/22	6-6-7-6	0.0	10-11': Similar to a	above		
1 7	10-12	24/22	0-0-7-0	0.0	11-12': White, light Brown fine to	medium SAND, dry.		
12							1	
1 1	12-14'	24/23	8-10-11-11	0.1	Similar to above	/e		
14							1	
1 4								
							1	
16-							1	
10							1	
							1	
1							1	
							1	
18			1				\vdash	
							1	
4	18-20'	24/6	5-28-35-31	0.1	Similar to above	/e	1	
		•					1	
20							L	
20					No debris encoun	tered		
IJ								! !
1 1								! !
21 –								! !
								! !
H-	GRANULAF	2 2011 2	T T		COHESIVE SOILS	T		WELL KEV:
L	GRANULAR	JUILO	Ļ		COULÇINE SOILS		_	WELL KEY:

GIVANUL	AIX SOILS	COLLESIVE SOLES		
BLOWS/ft	DENSITY	BLOWS/ft	CONSISTENCY	
0-4	V. LOOSE	<2	V. SOFT	
4-10	LOOSE	2-4	SOFT	
10-30	M. DENSE	4-8	M. STIFF	
30-50	DENSE	8-15	STIFF	
>50	V.DENSE	15-30	V.STIFF	
		>30	HARD	

NOTES:

1. Boring Logged by EndPoint personnel.



SOIL BORING LOG 323 Orleans Road Chatham, Massachusetts

Drilling Utility	Well Specifications
Drilling Co.: TDS, Inc.	Type: NA
Foreman:	Well Dia.: NA
Vehicle: Truck Rig	Well Matl.: NA
Model CME 75	Depth(ft): NA
Method: 3" Split Spoon	Screen Int.: NA
Sampler: 2ft	Wellhead: NA
Hammer(lb): 140	Ground Elev.: NA
Fall(in): 30	Wellhead Elev.: NA

					Chatham, Massachusetts	Fall(in): 30	We	ellhead Elev.: NA
\vdash			T	(")	Boring Location:	Tall(III). 30	***	IIIIcad Liev NA
				Ĭ	WTC Coordinates: N	E		
	O	Ë	s s	(e)	Ground Surface Elevation:			
Œ	c) (£)	Ö	를 등	RE	Date Started:	1/30/2017		WELL / STRATIGRAPHY
Ī) ra	Œ	l So :	SC	Date Completed:	1/30/2017		DIAGRAM
L	atig	\ \\\\\\\\\\\\\\\\\\\\\\\\\\\\\\\\\\\\	× .	n B	GW depth at time of installation (ft):	NA	Щ —	
DEPTH (ft)	Stratigraphic Interval (ft)	PEN/REC (in)	Blow Counts (per 6" inches)	FIELD SCREENING (ppm Benzene)	SAMPLE DESCRIF		NOTE	
0	0) =	Ш	Ш	шэ	SAMIFLE DESCRIF	TION		
1 07							1	
1 -	0-2'	24/20	10-8-9-11	0.0	Yellowish-orange, fine	SAND, dry.		
					_			
2								
1 4								
4			+					
			1					
	4-6'	24/24	11-9-11-14	0.0	4'-5': Similar to a	bove		
1 1	4-6	24/24	111-9-11-14	0.0	5'-6': White, light brown, fine to			
			1		, 5	, · · ,		
6			1					
ľ			1					
			1					
-			1					
8-								
0-								
1 1								
10								
107								
1 4	10-12'	24/18	4-5-6-9	0.0	Similar to above	<i>v</i> e		
12								
1 4								
14			+					
			1					
I ₋I			1					
ı 7			1					
			1					
16 -			1					
			1					
			1					
1 1			1					
			1					
18								
,,,,								
			1					
I −I	18-20'	24/16	5-7-8-10	0	Similar to above, sign:	s of redox		
			1		, ,			
			1					
20 –			•		No debris encoun	tered		
					INO GEDITO ETICOUTI			
-								
24								
21 –								
 -				1				
	GRANULAF	R SOILS			COHESIVE SOILS			WELL KEY:
. 7	DI OMC/ft	DENCITY				CONCICTENCY		

GRANULA	AR SUILS	CONESIVE	: 50IL5
BLOWS/ft	DENSITY	BLOWS/ft	CONSISTENCY
0-4	V. LOOSE	<2	V. SOFT
4-10	LOOSE	2-4	SOFT
10-30	M. DENSE	4-8	M. STIFF
30-50	DENSE	8-15	STIFF
>50	V.DENSE	15-30	V.STIFF
		>30	HARD

NOTES:

1. Boring Logged by EndPoint personnel.



SOIL BORING LOG 323 Orleans Road Chatham, Massachusetts

Drilling Utility	Well Specifications
Drilling Co.: TDS, Inc.	Type: NA
Foreman:	Well Dia.: NA
Vehicle: Truck Rig	Well Matl.: NA
Model CME 75	Depth(ft): NA
Method: 3" Split Spoon	Screen Int.: NA
Sampler: 2ft	Wellhead: NA
Hammer(Ib): 140	Ground Elev.: NA
Fall(in): 30	Wellhead Elev.: NA

					Chatham, Massachusetts	Hammer(lb): 140		round Elev.: NA
		1		(D	Design Location	Fall(in): 30	We	llhead Elev.: NA
				N	Boring Location:	E		
	0	(c)	Blow Counts (per 6" inches)	FIELD SCREENING (ppm Benzene)	WTC Coordinates: N Ground Surface Elevation:			
æ	ξ. Fi	=	at H	Sen SE	Date Started:	1/30/2017		WELL / STRATIGRAPHY
DEPTH (ft)	Stratigraphic Interval (ft)	PEN/REC (in)	jo ž	SCF 3nz	Date Started: Date Completed:	1/30/2017		DIAGRAM
Ė	tig. .va	$\overline{\mathbb{A}}$	Q 5	D S	GW depth at time of installation (ft):	NA	— ш	DIAGNAM
朌	te ta		S P	P E E			NOTE	
	is ⊑	₫.	<u>B</u> ⊖	교으	SAMPLE DESCRIF	PTION	Ž	
0							1	
							1 '	
_	0-2'	24/19	6-5-8-7	0.0	Yellowish-orange, fine to me	dium SAND, drv.		
	-				3.7	, , ,		
2								
1 1								
4								
[*]								
-	4-6'	24/19	9-13-16-16	0.0	Yellowish-orange, fine to medium SAND, s	ome fine to coarse Gravel, dry.		
						•		
6			1				-	
L								
7								
8 -								
1								
10			+					
-	10-12'	24/20	5-6-7-9	0.0	Light brown, fine to mediu	m SAND, dry.		
12								
12								
-								
14 -							$\overline{}$	
J								
7								
16-								
			1					
-								
18						<u></u>		
10								
4	18-20'	24/21	7-9-10-9	0.1	Light brown, fine to medium SAND, som	e fine to coarse Gravel, dry.		
ı	-				,	, . ,		
20 –			•		No debris encour	ntered		***************************************
					140 debits effectual	10100		
-								
١ , ا								
21 –								
	GRANULAF	RSOILS			COHESIVE SOILS			WELL KEY:

GRANULAR SOILS		COHESIVE SOILS	
BLOWS/ft	DENSITY	BLOWS/ft	CONSISTENCY
0-4	V. LOOSE	<2	V. SOFT
4-10	LOOSE	2-4	SOFT
10-30	M. DENSE	4-8	M. STIFF
30-50	DENSE	8-15	STIFF
>50	V.DENSE	15-30	V.STIFF
		>30	HARD

NOTES:

1. Boring Logged by EndPoint personnel.



SOIL BORING LOG 323 Orleans Road Chatham, Massachusetts

Drilling Utility
Drilling Co.: TDS, Inc. Well Specifications
Type: NA Well Dia.: NA Foreman: Vehicle: Truck Rig Well Matl.: NA Model CME 75 Depth(ft): NA Method: 3" Split Spoon Screen Int.: NA Sampler: 2ft Wellhead: NA Hammer(lb): 140 Ground Elev.: NA

					Chatham, Massachusetts	Hammer(lb): 140		Ilhead Elev.: NA
\vdash			T	(D	Boring Location:	Fall(in): 30 Adjacent to building to the west	vve	ilileau Elev INA
				FIELD SCREENING (ppm Benzene)	WTC Coordinates: N	E		
	O	(C)	Blow Counts (per 6" inches)	e E	Ground Surface Elevation:			
æ	÷ ji	i.	ti ë	ZE.	Date Started:	1/30/2017		WELL / STRATIGRAPHY
<u> </u>	тар (Щ	ું .≘	SCI	Date Completed:	1/30/2017		DIAGRAM
Ė	tig Va	K K	> <u>"</u> 9	D S	GW depth at time of installation (ft):	NA	— ш	DI/ CITO (W
DEPTH (ft)	Stratigraphic Interval (ft)	PEN/REC (in)	<u>6</u> <u>6</u>	P EL			NOTE	
	o =		<u>а</u> <u>э</u>	<u> </u>	SAMPLE DESCRI	PTION	Z	
○ T							1	
							'	
1 4	0-2'	24/19	2-3-5-7	0.0	Yellowish-orange, fine to medium SAND, s	some fine to coarse Gravel, dry.		
	-				,	, , , , , , , , , , , , , , , , , , , ,		
1 1								
2							_	
1 1								
1 1								
1 1								
4			_	igwdot				
1								
1 -	4-6'	24/8	2-2-2-2	0.0	Yellowish-orange, fine to medium SA	ND, trace fine gravel, dry.		
6							\neg	
1 1								
8 –								
1 4				$oxed{oxed}$				
L								
1 1					9-10': Similar to	ahaya		
10 -	9-11'	24/10	12-6-3-4	0.0				
					10-11': Dark grey, fine to medium SAND, son	ie Siit, some fine to coarse Gravei.		
1 1								
1 1								
1 1								
12	11-13'	24/24	4-3-3-4	0.0	11-12': Similar to			
				0.0	12-13': Yellowish-orange, fine to medium	n SAND, trace fine gravel, dry.		
1 1								
I +							_	
14 -	13-15'	24/24	4-6-8-7	0.0	Yellowish-orange, fine to medium SAND, s	name fine to ecores Crovel dry		
14-	13-13	24/24	4-0-0-7	0.0	reliowish-orange, line to medium SAND, s	some line to coarse Graver, dry.		
I ∔								
					No debris ident	tified		
10								
16 -								
ı J								
1								
18 -								
1 1								
20 -								
20								
1 1								
21 -								
217								
╙								
1	GRANULAF	RSOILS	1	1	COHESIVE SOILS			WELL KEY:

GRANULAR SOILS	COHESIVE	SOILS	WELL K
BLOWS/ft DENSITY	BLOWS/ft	CONSISTENCY	RISER
0-4 V. LOOSE	<2	V. SOFT	SCREE
4-10 LOOSE	2-4	SOFT	BENTO
10-30 M. DENSE	4-8	M. STIFF	WELL S
30-50 DENSE	8-15	STIFF	FILL
>50 V.DENSE	15-30	V.STIFF	FILL PORTLA
	>30	HARD	

KEY: ΕN ONITE SAND LAND

NOTES:

^{1.} Boring Logged by EndPoint personnel.

SYSTEM # Chatham Works - System 1C

1. Area of contribution (A)

Impervious area:

 Pavement Area
 4580 S.F. = 0.105 Acres

 Roof Area
 7260 S.F. = 0.167 Acres

 Pervious area (Grass):
 1330 S.F. = 0.031 Acres

 Total area
 13170 S.F. = 0.302 Acres

- 2. Composite coefficient of runoff (C)
 - = (Impervious area * 0.98) + (Pervious area * 0.39) / Total area

= 0.92

- 3. Rainfall intensity (i) from formula: i = 230 / (time of concentration[in minutes] + 30)

 2.80 inches per hour for 60 minute duration
- 4. Average runoff (Q) = CiA in c.f. per sec. (for initial sizing of leaching facility)

= 0.92 * 2.80 in/hr * 0.30

= 0.8 c.f. per sec. for 60 min duration or 46.8 c.f. per min. for 60 min duration

5. Infiltration rate of soils (permeability) from tables

= 0.70 gal per min. per s.f. / 7.5 gal per c.f.

= 0.09 c.f. per min. per s.f.

- 6. Infiltration area required to leach average runoff
 - = (Q c.f. per sec. * 60 sec per min.) / infiltration rate in c.f. per min. per s.f.

= 501 s.f. required

7, Initial sizing of system (using 6 ft dia. leach pit) to meet the required infiltration area


2 six foot diameter leaching basin(s) 6 feet deep with 4.0 feet of stone all around

8. Infiltration area, sidewalls only (actual)

= # of structures * Diameter of system * pi *depth of system

= 2 basin(s) * 14 feet * pi 6 feet deep

= 528 s.f. provided

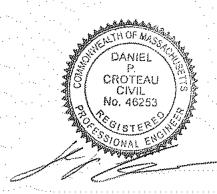

SYSTEM # Chatham Works - System 2

1. Area of contribution (A)

Impervious area:

 Pavement Area
 0 S.F. = 0.000 Acres

 Roof Area
 2390 S.F. = 0.055 Acres

 Pervious area (Grass):
 0 S.F. = 0.000 Acres

 Total area =
 2390 S.F. = 0.055 Acres

- 2. Composite coefficient of runoff (C)
 - = (Impervious area * 0.98) + (Pervious area * 0.39) / Total area

= 0.98

- 3. Rainfall intensity (i) from formula: i = 230 / (time of concentration[in minutes] + 30)

 2.80 inches per hour for 60 minute duration
- 4. Average runoff (Q) = CiA in c.f. per sec. (for initial sizing of leaching facility)

= 0.98 * 2.80 in/hr * 0.05 acres = 0.2 c.f. per sec. for 60 min duration or 9.0 c.f. per min. for 60 min duration

- 5. Infiltration rate of soils (permeability) from tables
 - 0.70 gal per min. per s.f. / 7.5 gal per c.f.
 - = 0.09 c.f. per min. per s.f.
- 6. Infiltration area required to leach average runoff
 - = (Q c.f., per sec. * 60 sec per min.) / infiltration rate in c.f. per min. per s.f.


= 97 s.f. required

- 7. Initial sizing of system (using 6 ft dia. leach pit) to meet the required infiltration area
 - 2 six foot diameter leaching basin(s) 3 feet deep with 2.0 feet of stone all around
- 8. Infiltration area, sidewalls only (actual)

= # of structures * Diameter of system * pi *depth of system

= 2 basin(s) * 7 feet * pi 3 feet deep

= 132 s.f. provided

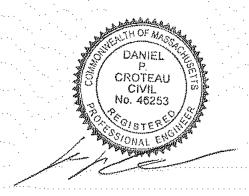

SYSTEM # Chatham Works - System 1A - Abutting property for comparison

1. Area of contribution (A)

Impervious area:

Pavement Area	5980 S.F. = 0.137	Acres
Roof Area	0 S.F. = 0.000	Acres
Pervious area (Grass):	2270 S.F. = 0.052	Acres
Total area =	8250 S.F. = 0.189	Acres

2. Composite coefficient of runoff (C)

= 0.82

3. Rainfall intensity (i) from formula: i = 230 / (time of concentration[in minutes] + 30)

2.80 inches per hour for 60 minute duration

4. Average runoff (Q) = CiA in c.f. per sec. (for initial sizing of leaching facility)

==	0.82 *	2.80 in/hr * 0.19	acres
==	0.4 c.f. per sec. for	60 min duration	
or	26.0 c.f. per min. for	60 min duration	

SYSTEM # Chatham Works - System 3 (for comparison with system 1A)

1. Area of contribution (A)

Impervious area:

Pavement Area	3100 S.F. = 0.071 Acres
Roof Area	460 S.F. = 0.011 Acres
Pervious area (Grass):	7460 S.F. = 0.171 Acres
Total area =	11020 S.F. = 0.253 Acres

2, Composite coefficient of runoff (C)

= 0.58

3. Rainfall intensity (i) from formula: i = 230 / (time of concentration[in minutes] + 30)

2.80 inches per hour for 60 minute duration

4. Average runoff (Q) = CiA in c.f. per sec. (for initial sizing of leaching facility)

===	0.58 *	2,80 in/hr * 0.25 acre
==	0.4 c.f. per sec. for	60 min duration
or	24.7 c.f. per min. for	60 min duration

