

- 2.) CONTRACTOR TO VERIFY ALL INTERIOR & EXTERIOR MATERIALS,
- 3.) ROUGH OPENING HEAD HEIGHT OF WINDOWS AT FIRST FLOOR TO BE 6'-8" ABOVE SUBFLOOR
- 4.) ALL CONSTRUCTION TO CONFORM TO 780 CMR MASSACHUSETTS STATE BUILDING CODE, 8TH EDITION AMENDEMENT & IRC2009
- 5.) 110 MPH EXPOSURE B WIND ZONE
- 6.) ALL SHEETS OF PLYWOOD WALL SHEATHING TO BE INSTALLED VERTICALLY, OR HORIZONTALLY W/ BLOCKING AT EDGES, 3"EDGE/12" FIELD NAILING
- 7.) ALL LVL LUMBER/BEAMS TO BE 1.9e L/360 LOAD
- 8.) SEE CERTIFIED PLOT PLAN DEVELOPED BY CAPESURV FOR ALL PROPOSED & EXISTING DETAILS
- 9.) FOLLOW ALL MANUFACTURER'S SPECIFICATIONS FOR INSTALLATION OF ALL SIMPSON COMPONENTS
- 10.) ALL CONCRETE USED FOR FOUNDATION WALLS, FOOTINGS & SLABS TO BE 3000 PSI
- 11.) VERIFY ALL PLUMBING & ELECTRICAL DETAILS W/ OWNERS ON THE SITE DURING FRAMING CONSTRUCTION
- 12.) TIMBER FRAMING TO BE SPRUCE/PINE/FIR NO. 2 GRADE
- 13.) FOLLOW ALL REQUIREMENTS OF THE 110 MPH CHECKLIST SUPPLIED
- 14.) FOLLOW ALL REQUIREMENTS OF THE IECC2015 RESIDENTIAL ENERGY EFFICIENCY REQUIREMENTS & VERIFY ALL DETAILS WITH THE INSULATION INSTALLER/CONTRACTOR.
- 15.) ALL HEADERS LESS THAN 4'0" TO BE 3- 2 x 6's UNLESS OTHERWISE NOTED

NOTES:

1.) CONTRACTOR IS TO VERIFY ALL EXISTING CONDITIONS & DIMENSIONS IN THE FIELD

- DETAILS, & FINISHES IN THE FIELD WITH OWNER
- **EXISTING WALLS** CONSTRUCTION TO BE REMOVED
- NEW CONSTRUCTION

FIRST FLOOR PLAN

S SMOKE DETECTOR

LEGEND:

(C) CARBON MONOXIDE DETECTOR

IECC2015 RESIDENTIAL ENERGY EFFICIENCY DETAILS


CLIMATE ZONE 5 (USE EITHER PRESCRIPTIVE VALUES OR RESCHECK CALCULATION TABLE 402.1.2 (MINIMUM PRESCRIPTIVE INSULATION & FENESTRATION REQUIREMENTS) FENESTRATION | SKYLIGHT | CEILING | WOOD FRAMED WALL | FLOOR | BASEMENT WALL | BASEMENT SLAB | CRAWL SPACE WALL U-FACTOR U-FACTOR R-VALUE R-VALUE R-VALUE | R-VALUE R-VALUE R-VALUE 10 (4 FT. DEEP) | 15/19

1. R-VALUES ARE MINIMUMS & U-FACTORS ARE MAXIMUMS.

- 2. 15/19 MEANS R=15 CONTINUOUS INSULATED SHEATHING ON THE INTERIOR OR EXTERIOR OF THE HOME OR R=19 INSULATION CAVITY AT THE INTERIOR OF THE BASEMENT WALL
- 3. REFER TO IECC 2015 CHAPTER 4 FOR ALL INSULATION & ENERGY REQUIREMENTS 4. 13 + 5 MEANS R5 CONTINUOUS INSULATED SHEATHING ON THE WALL EXTERIOR & R13 CAVITY INSULATION

COTUIT BAY DESIGN, LLC 43 BREWSTER ROAD MASHPEE, MA. 02649 PH. (508) 274-1166 FAX (508) 539-9402

NEW ADDITION FOR: GARDNER RESIDENCE 6 GARDNER'S PATH, CHATHAM, MA

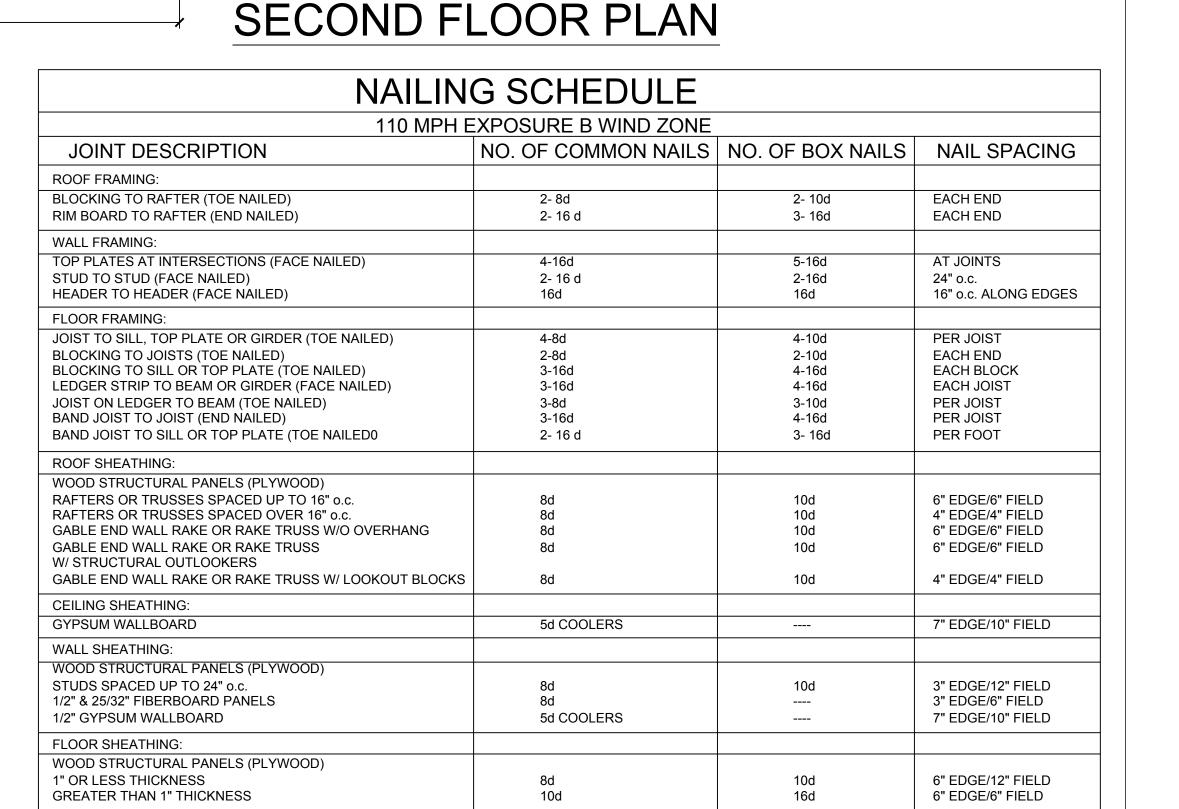

2 x 8 RAFTERS

WIND WASH

1 x 3 STRAPPING W/ 1/2" GYPSUM BOARD—

EXIST

BEDROOM

BARRIER ·

(SHED DORMER)

ANDERSEN

TW2432

2'6" PKT. DOOR

ANDERSEN

TW2432

BEDROOM

ACCESS

PANEL

ANDERSEN

TW24310

THE DESIGNER SHALL BE NOTIFIED IF ANY ERRORS OR OMISSIONS ARE FOUND ON THESE DRAWINGS PRIOR TO START OF CONSTRUCTION. THE BUILDING CONTRACTOR WILL BE RESPONSIBLE FOR THE CONTENT IN THESE DRAWINGS IF CONSTRUCTION COMMENCES WITHOUT NOTIFYING THE DESIGNER OF ANY FRRORS OR OMISSIONS THESE DRAWINGS ARE SOLELY FOR THE USE OF THE OWNER NOTED. ANY OTHER USE OF THESE DRAWINGS REQUIRES THE WRITTEN CONSENT OF THE DESIGNER UNDER THE

ARCHITECTURAL COPYRIGHT PROTECTION

SCALE: 1/4" = 1'-0"

TYPICAL ASPHALT **ROOF SHINGLES**

— 15# FELT PAPER

DETAIL AT WALL

SCALE: 1/2" = 1'-0"

- 5/8" CDX PLYWOOD SHEATHING

AT ALL RAFTERS ENDS

— 3'0" WIDE ICE/WATER SHIELD

- ALUMINUM DRIP EDGE

USE SIMPSON H2.5A HURRICANE CLIPS

- NEW PVC FASCIA, FRIEZE, & SOFFIT

BOARDS TO MATCH EXISTING

DATE



DRAWING NO.